


- 1. ALL ELECTRICAL, PLUMBING & COMPRESSED AIR LINES AND CONNECTIONS ARE THE <u>RESPONSIBILITY OF THE OWNER/GENERAL CONTRACTOR</u> AND ARE TO BE MADE BY QUALIFIED LICENSED PERSONNEL TO MEET STATE AND LOCAL CODES. NEITHER AUTEC OR THEIR REPRESENTATIVES SUPPLY OR INSTALL THESE ITEMS.
- 2. ALL MOUNTING HEIGHT DIMENSIONS STATED ON DRAWINGS ARE TO THE BOTTOM OF ITEM. (A.F.F.) = ABOVE FINISHED FLOOR.
- 3. GLASS CAR WASH BUILDING BY AUTEC FOUNDATION / SLAB BY OTHERS.

ALL REQUIRED ELECTRICAL AND PLUMBING ITEMS ARE TO CONFORM TO STATE AND LOCAL CODES.

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AMBIENT ROOM TEMPERATURE AT AUTEC MAIN CONTROL PANEL LOCATION NOT TO EXCEED 120° F (48.8° C) TO PREVENT MALFUNCTION OR PERMANENT DAMAGE TÓ PLC

> GRAINGER #1HLA5 DAYTON EXHAUST FAN WITH AUTOMATIC FAN SHUTTER (REQUIRES LINEVOLTAGE THERMOSTAT)

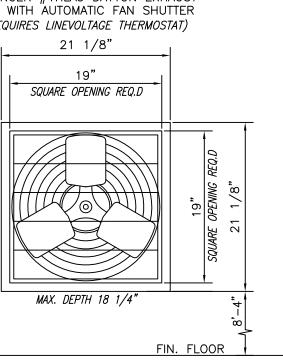


ITEM EQ. ROOM EXHAUST FAN DETAILS


54 SCALE: NONE


STANDARD LENGTHS OF SINGLE LINE $\emptyset 3/8$ " & $\emptyset 1/2$ " I.D. BRAIDED CHEMICAL HOSE SUPPLIED BY AUTEC FOR CHEMICAL DELIVERY FROM CHEMICAL PUMPS AT MIXING STATIONS TO WASH BAY CONNECTIONS ARE 50 FT. CONTACT AUTEC TO ORDER ADDITIONAL HOSE IF REQUIRED. INBAY EXPRESS - EV1 SYSTEM CHEMICAL STATIONS (DOUBLE PRE SOAK + ON BOARD SOAP + TRIPLE FOAM SOAP + CTA + GRIME BUSTER + CC + RX/TEC SHIELD) BRAIDED CHEMICAL HOSE (BY AUTEC *) RUN FROM CHEMICAL PUMPS TO WASH BAY PRE SOAK STANDS CONNECTIONS — BY CAR WASH INSTALLER. EV1 PRE SÒAK #1 PRE, SOAK #2 GRIME CLEAR RAIN-X or CTA BUSTER COAT TEC SHIELD ON BOARD #1 OPTIONAL "TWIN-PACK" (PRE-SOAK, CTA & GRIME BUSTER) CHEMICAL MIXING WITH AMS100

				28	PCW-4500HV-HP	PUR-CLEAN SPOT FREE RINSE SYSTEM - WALL MOUNT (4500 GPD) WITH 2 CU. FT.	1
57	CV/VAC-001	FRAGRAMATICS ECONOMY VAC - SUPER VACUUM WITH COMPUTER CONTROLLED TIMER	2	†		CARBON FILTER WITH AUTO BACKFLUSH & (SFHV-HP) 3 HP REPRESSURIZATION PUMP;	
		STAINLESS STEEL TANK, INCLUDES Ø1-1/2" X 15 FT. VAC HOSE. (BY DEALER)		†		AUTOMATIC MEMBRANE BACKFLUSH; 27 GPM @ 80-100 PSI OUTPUT.	
56	TSS-940-PED42	48"x 6"x 5.5" NEON LETTER STICKS — w/MOUNTING PEDESTAL (BY OWNER)	10	t		(SUPPLIED BY DEALER — INSTALLED BY OTHERS)	
		(FUTURE ADDITION — SHOWN FOR ROUGH—IN ONLY)		27	ACT-99-S	COUNTDOWN TIMER w/STAND — STAINLESS STEEL CASE — DRYER TIME DISPLAY	1
55	NLCB-SX	NEON LIGHT CONTROL PANEL/SIEMENS EXPANDED PLC, OPERATES 16 FUNCTIONS AND 2 WASH	1	26	BFS-45	AUTEC 45 HP TOUCHFREE BLOWER. (3) 15 HP STAINLESS STEEL ENCLOSED OVERHEAD	1
	NEOD 3X	PACKAGES. ENABLES LIGHTS TO REMAIN ON & FLASH AS FUNCTION OCCURS (INCLUDES FLASHERS)	'	120	B13 13	FANS. INCLUDES MOTOR STARTER AND GUIDE RAILS. 175 AMP SERVICE REQUIRED.	<u> </u>
		(FUTURE ADDITION — SHOWN FOR ROUGH—IN ONLY)		25	BFS-30	AUTEC 30HP TOUCHFREE BLOWER. (2) 15 HP STAINLESS STEEL ENCLOSED OVERHEAD	1
54	 1HLA5	GRAINGER DAYTON 18" DIA. EXHAUST FAN (1/4 HP, 115V, 4.5 AMP MOTOR) 19"	1	1 25	B13 30	FANS. INCLUDES MOTOR STARTER AND GUIDE RAILS. 125 AMP SERVICE REQUIRED.	
5	TTLAS	SQUARE OPENING REQUIRED — INCLUDES AUTOMATIC SHUTTER. (BY OWNER)	'	24	ACT-99-S	COUNTDOWN TIMER w/STAND - STAINLESS STEEL CASE - RINSE TIME DISPLAY	
53	222A-2586-EQ	AUTEC EXTERIOR EQUIPMENT ROOM — 24'-9" x 8'-6" w/POWDER	1	23	ARA-UNI	UNIVERSAL STAINLESS STEEL RINSE/PRE—SOAK ARCH w/ 17 NOZZLES — ADJUSTS	-
33	222A-2500-LQ	COATED ALUMINUM FRAME (COLOR SPECIFIED BY OWNER); 5/8"THK. INSULATED CLEAR	'	23	AIXA-OIVI	FROM 8 TO 15 FT. WIDE, INCLUDES CHEMICAL INJECTION PORT (CHEMICAL PUMPING	<u> </u>
		POLYCARBONATE SIDEWALL CONSTRUCTION & 3' MAN DOOR TO WASH BAY.		+		STATIONS NOT INCLUDED)	
52	DOOR-3-69	EXTERIOR PASSAGEWAY DOOR - 3-0 x 6-9	1	22	CBA-1-SS	*	
	222A-RRP		•	22	CBA-1-22	BUG BUSTER (STAINLESS STEEL) - APPLIES GRIME BUSTER PRE-SOAK TO FRONT OF	
51		AUTEC RETRACTABLE ROOF PANELS	2	0.1	ADA HAH ZV	VEHICLE TO ENHANCE REMOVAL OF BUGS AND TAR. INCLUDES CHEMICAL STATION.	
50	222A-6520	AUTEC CAR WASH BUILDING - 65' X 20' X 11'-6" H. W/POWDER COATED ALUMINUM	ı	21	ARA-UNI-3X	UNIVERSAL STAINLESS STEEL TRIPLE FOAM ARCH, ADJUSTS FROM 8 TO 15 FT. WIDE,	_
		FRAME (COLOR SPECIFIED BY OWNER); 5/8" THK. FULL HEIGHT INSULATED FIXED				INCLUDES FOAMING CHAMBERS & NOZZLE TUBES (CHEMICAL PUMPING STATIONS	
		GLASS SIDEWALL CONSTRUCTION		<u> </u>		NOT INCLUDED)	
49	OMHL	LITHONIA BAY FIXTURE (MODEL #TXR-400M-PA22C) - 400W METAL HALIDE	12	20	ARA-HPS	STAINLESS STEEL HEATED PRE-SOAK ARCH w/ 17 NOZZLES - ADJUSTS FROM 8 TO	
48	DX-30-100-SS	RE-VERBER-RAY 100,000 BTU GAS FIRED RADIANT HEATER, 31'-3" LENGTH (BY DEALER)	1	-		15 FT. WIDE, INCLUDES RECIRCULATION VALVES AND FOAMING CHAMBER (HEATED	
47	TSS-A153S	30" LONG x 48" HIGH 7 SECTION LIGHTED CABINET w/STROBES MOUNTED ON A 30"	1	ļ		CHEMICAL PUMPING STATION NOT INCLUDED)	
		PEDESTAL EACH SECTION LIGHTS WITH CORRESPONDING WASH FUNCTION (DRIVE FOREWARD;		19	APS-HPA	HEATED CHEMICAL PUMPING STATION (USED FOR HEATED PRESOAK ARCH APPLICATION)	<u> </u>
		STOP; BACK UP; TURN OFF WIPERS; CLEAR COAT PROTECTANT; SPOT FREE RINSE; EXIT)		18	ALC-1	A LA CARTE CONTROL BOX FOR PREMIUM ENTRY SYSTEM FUNCTION SELECTION	<u> </u>
46	TSS-148S	EXTERIOR 3 LIGHT CABINET W/SUNSHIELD (STOP, WIPERS ON, PLEASE WAIT/PAY)	1	17	AMS-100	AUTEC CHEMICAL MIXING STATION 28" X 52" INCLUDES 100 GAL POLY TANK & 1/3HP	
45	91919	FREEZE PROTECTION THERMOSTAT FOR DOOR OPERATION	1			115/208-230V 1PH MIXING MOTOR WITH CONTROL TIMER. (PUMP NOT INCLUDED)	
44	AUP-ADP	AUTEC UTILITY POST FOR AUTOMATIC DOOR CONTROL PANEL - STAINLESS STEEL	2	16	DPS-CR	DUAL PUMPING STATION CREDITS (REMOVES CHEMICAL MIXING STATION FROM ONE SET OF PUMPS)	
43	MGH111	AIRLIFT MAGNA GLIDE HORIZONTAL DOOR OPERATORS, 8 FT./REQUIRES 40-80 PSI AIR SERVICE	2	15	APS-1C	AUTEC CHEMICAL PUMPING STATION - WALL MOUNT WITH CLEAR PVC MIXING CANISTER,	
		INCLUDES PHOTO EYES & WATERPROOF 2 BUTTON CONTROL BOX (110V) (BY DEALER)				INCLUDES SINGLE AIR PUMP FOR CHEMICAL DELIVERY (3-SOAP, CLEAR COAT, TEC SHIELD)	
42	10-2X10ECH0	AIRLIFT ALASKA 10'-2" W. x 10' H. EXTREME POLYCARBONATE DOORS w/ STRAPEZE	2	14	RPM-1	22-FUNCTION REMOTE PAGING MONITOR (REQUIRES DEDICATED ANALOG PHONE LINE - BY OWNER)	
		COUNTER BALANCE SYSTEM, (1) 5/8" CLEAR VIEW SECTION, STAINLESS STEEL FACE		13	ABSK-1	BELL HOSE SWITCH ASSEMBLY FOR PRE & POST WASH FUNCTIONS	
		HARDWARE KIT, GALVANIZED SHAFT & SUPERGLIDE BEARINGLESS ROLLERS. (BY DEALER)		12	APE-1	PHOTO-EYE SWITCH SETS FOR PRE & POST WASH FUNCTIONS (TRANSMIT AND RECEIVE) w/POWER CORDS	
41	VIDEO KIT	8 VIDEO SURVEILLANCE CAMERAS WITH COMPUTER CONTROL, MONITOR AND POWER	1	11	TFA-R	TREADLE FREE ACTIVATION UPGRADE - REAR OF VEHICLE (ENTRANCE END) HOME POSITION	
		SUPPLY (BY DEALER).		10	GRC-N	GUIDE RAIL COVERS. PRE INSTALLED 10 FT. TIRE PROTECTOR UPGRADE FOR GUIDE RAIL SETS	
40	VRV5-6	CHAMPION AIR COMPRESSOR (5HP-3PH) 60 GAL. VERTICAL TANK (19.1 CFM @ 125 PSI)	1	9	CD-1	CUSTOM DECAL FOR MACHINE HEADER PANELS	
39	PORTAL TI-EV	UNITEC ENTRY SYSTEM w/STAND-ACCEPTS RANDOM CODES, COINS, BILLS, CREDIT	1	8	CD-A	CUSTOM DECAL ARTWORK	
		CARDS, WASH CARDS, COUPONS & FLEET CODES. GIVES CHANGE. INCLUDES VOICE		7	AST-1	SAFE TAG FRONT LICENSE PLATE PROTECTOR - (2) TWO STAGE SIDE BRUSH CYLINDERS	
		MESSAGING OPTION, PROXIMITY SENSOR. INCLUDES POS UNIT. (BY DEALER)		6	ATB-1	TREADLE BUZZER	
38		PRECAST CONCRETE CATCH BASIN w/ FRAME & GRATE; 2' W x 3' L x 4' DEEP (BY OWNER)	1	5	RSC-2	REAR SUPER CLEAN UPGRADE (REAR ARM INCLINED TO FIT VEHICLE CONTOUR, REQUIRES PFU-1 OPTION)	
37		1500 GAL. CAP. PRECAST CONCRETE 3-SECTION RECLAIM TANK (BY OWNER)	2	4	PFU-1	SOFT TOUCH POLYFLEX UPGRADE ON NEW MACHINE VS. SOFT CLOTH	
36	PW-200-5	PUR-WATER RECLAIM SYSTEM - 60 GPM @ 40 PSI w/ ODOR CONTROL (BY DEALER)	1	3	ACTA-OB	AUTEC CHEMICAL TIRE APPLICATOR W/PUMP — CHEMICAL APPLIED ON BOARD MACHINE	
35	AWWS-EXTEND	AUTEC WINDOW WASHING SYSTEM CONTROL PANEL FOR BUILDINGS OVER 49 FT. LONG	1	2	AUW-1-SS	AUTEC UNDERCARRIAGE WASH — STAINLESS STEEL	\vdash
		INCLUDES ADDITIONAL OUTPUTS FOR CONTROLLING WATER VALVES ON LONGER RUNS.		1	EV-1-300	AUTEC EVOLUTION SOFT TOUCH/TOUCHLESS COMBINATION VEHICLE WASHER - ALL STAINLESS	┢
34	AWWS-1	AUTEC WINDOW WASHING SYSTEM - 4 RINSE MANIFOLDS IN 16' SECTIONS THAT	2	 		STEEL WITH COMPLETE MITTER RETRACT (FORE AND AFT), WATER BASED HYDRAULICS, TANK	
- '		COVER A TOTAL OF 32 LINEAR FEET. DESIGNED FOR GLASS BUILDINGS.				HEATER, STAINLESS STEEL GUIDE RAILS, TREADLE RAMPS & TIRE STOPS. ON-BOARD RINSE	\vdash
33	F&W 2714	3 HP HIGH VOLUME, HIGH PRESSURE (27 GPM @ 80-100 PSI) PUMP W/CONTROL	1	1		CAPABILITY, SOAP PUMPING STATION, OFFERS SEVEN WASH PACKAGES AND CUSTOM WASH	\vdash
	1 CW 2717	(FOR RO REJECT WATER DELIVERY TO 1ST RINSE ARCH) (SUPPLIED BY DEALER)	'	1		SETUP CAPABILITIES. HEATED PRE-SOAK TANK WITH DELIVERY PUMP. EQUIPPED w/ QUICK	\vdash
32	ROCS	AUTEC R/O CHEMICAL SUPPLY SYSTEM - INCLUDES A 14 GAL. BLADDER TANK W/STAND,	1	1		RELEASE DOOR PANELS, GREASELESS BEARINGS, NOSE SCRUBBER AND REAR JOG FEATURES.	\vdash
JZ	1.003	1/2" DUAL FLO JET PUMPS AND ALL REGULATORS, VALVES, HOSES & FITTINGS TO	1	1		GANTRY JOG SWITCH IN CONTROL PANEL. INCLUDES EXTERIOR TWO LIGHT PACKAGE.	\vdash
		CONNECT TO THE R/O SYSTEM STORAGE TANK.		1		TOUCHLESS PORTION OF MACHINE INCLUDES A 20 HP PUMPING STATION THAT PUMPS UP	\vdash
71		,	4				-
31	, T 470	1/2 HP S.S. SUMP PUMP PACKAGE FOR R.O. SUPPLY FROM UNDERGROUND TANK (BY DEALER)	1	1		TO 35 GPM OF WATER THROUGH 48 OSCILLATING O' NOZZLES, EIGHT ADDITIONAL ON—BOARD	\vdash
30	T-130	130 GAL. CAPACITY POLYETHYLENE STORAGE TANK - \$\psi 23" \times 76" HIGH (BY DEALER)	1	1		TURBO NOZZLES ARE INCLUDED FOR SPRAYING TIRES, WHEELS & ROCKER PANELS.	_
29 TEM	NW-060040278 PART No.	1700 GAL. CAP. POLY. TANK FOR R.O. STORAGE - 55" x 143" x 66" DEEP (BY OWNER)	7	ITC. (DADT N	(INCLUDES 300 GAL. WATER TANK TO FEED PUMPING STATION, BAY BOOM & RINSE ARCH).	
	PAKI NO	DESCRIPTION	QUAN.	III∟M	PART No.	DESCRIPTION	QL

A PROPOSED PLAN OF: STAPLETON EASTRIDGE CAR WASH, LLC DENVER, COLORADO PRESENTED BY: EQUIPMENT LIST NO. DATE DESCRIPTION BY CHKD. AND DETAILS REVISIONS ENGINEER: DRAWN BY: DRAWING NO. CMR 03-02-2009 EV1-0144 0 SCALE: AS SHOWN CHECKED: SHEET 1 OF 12

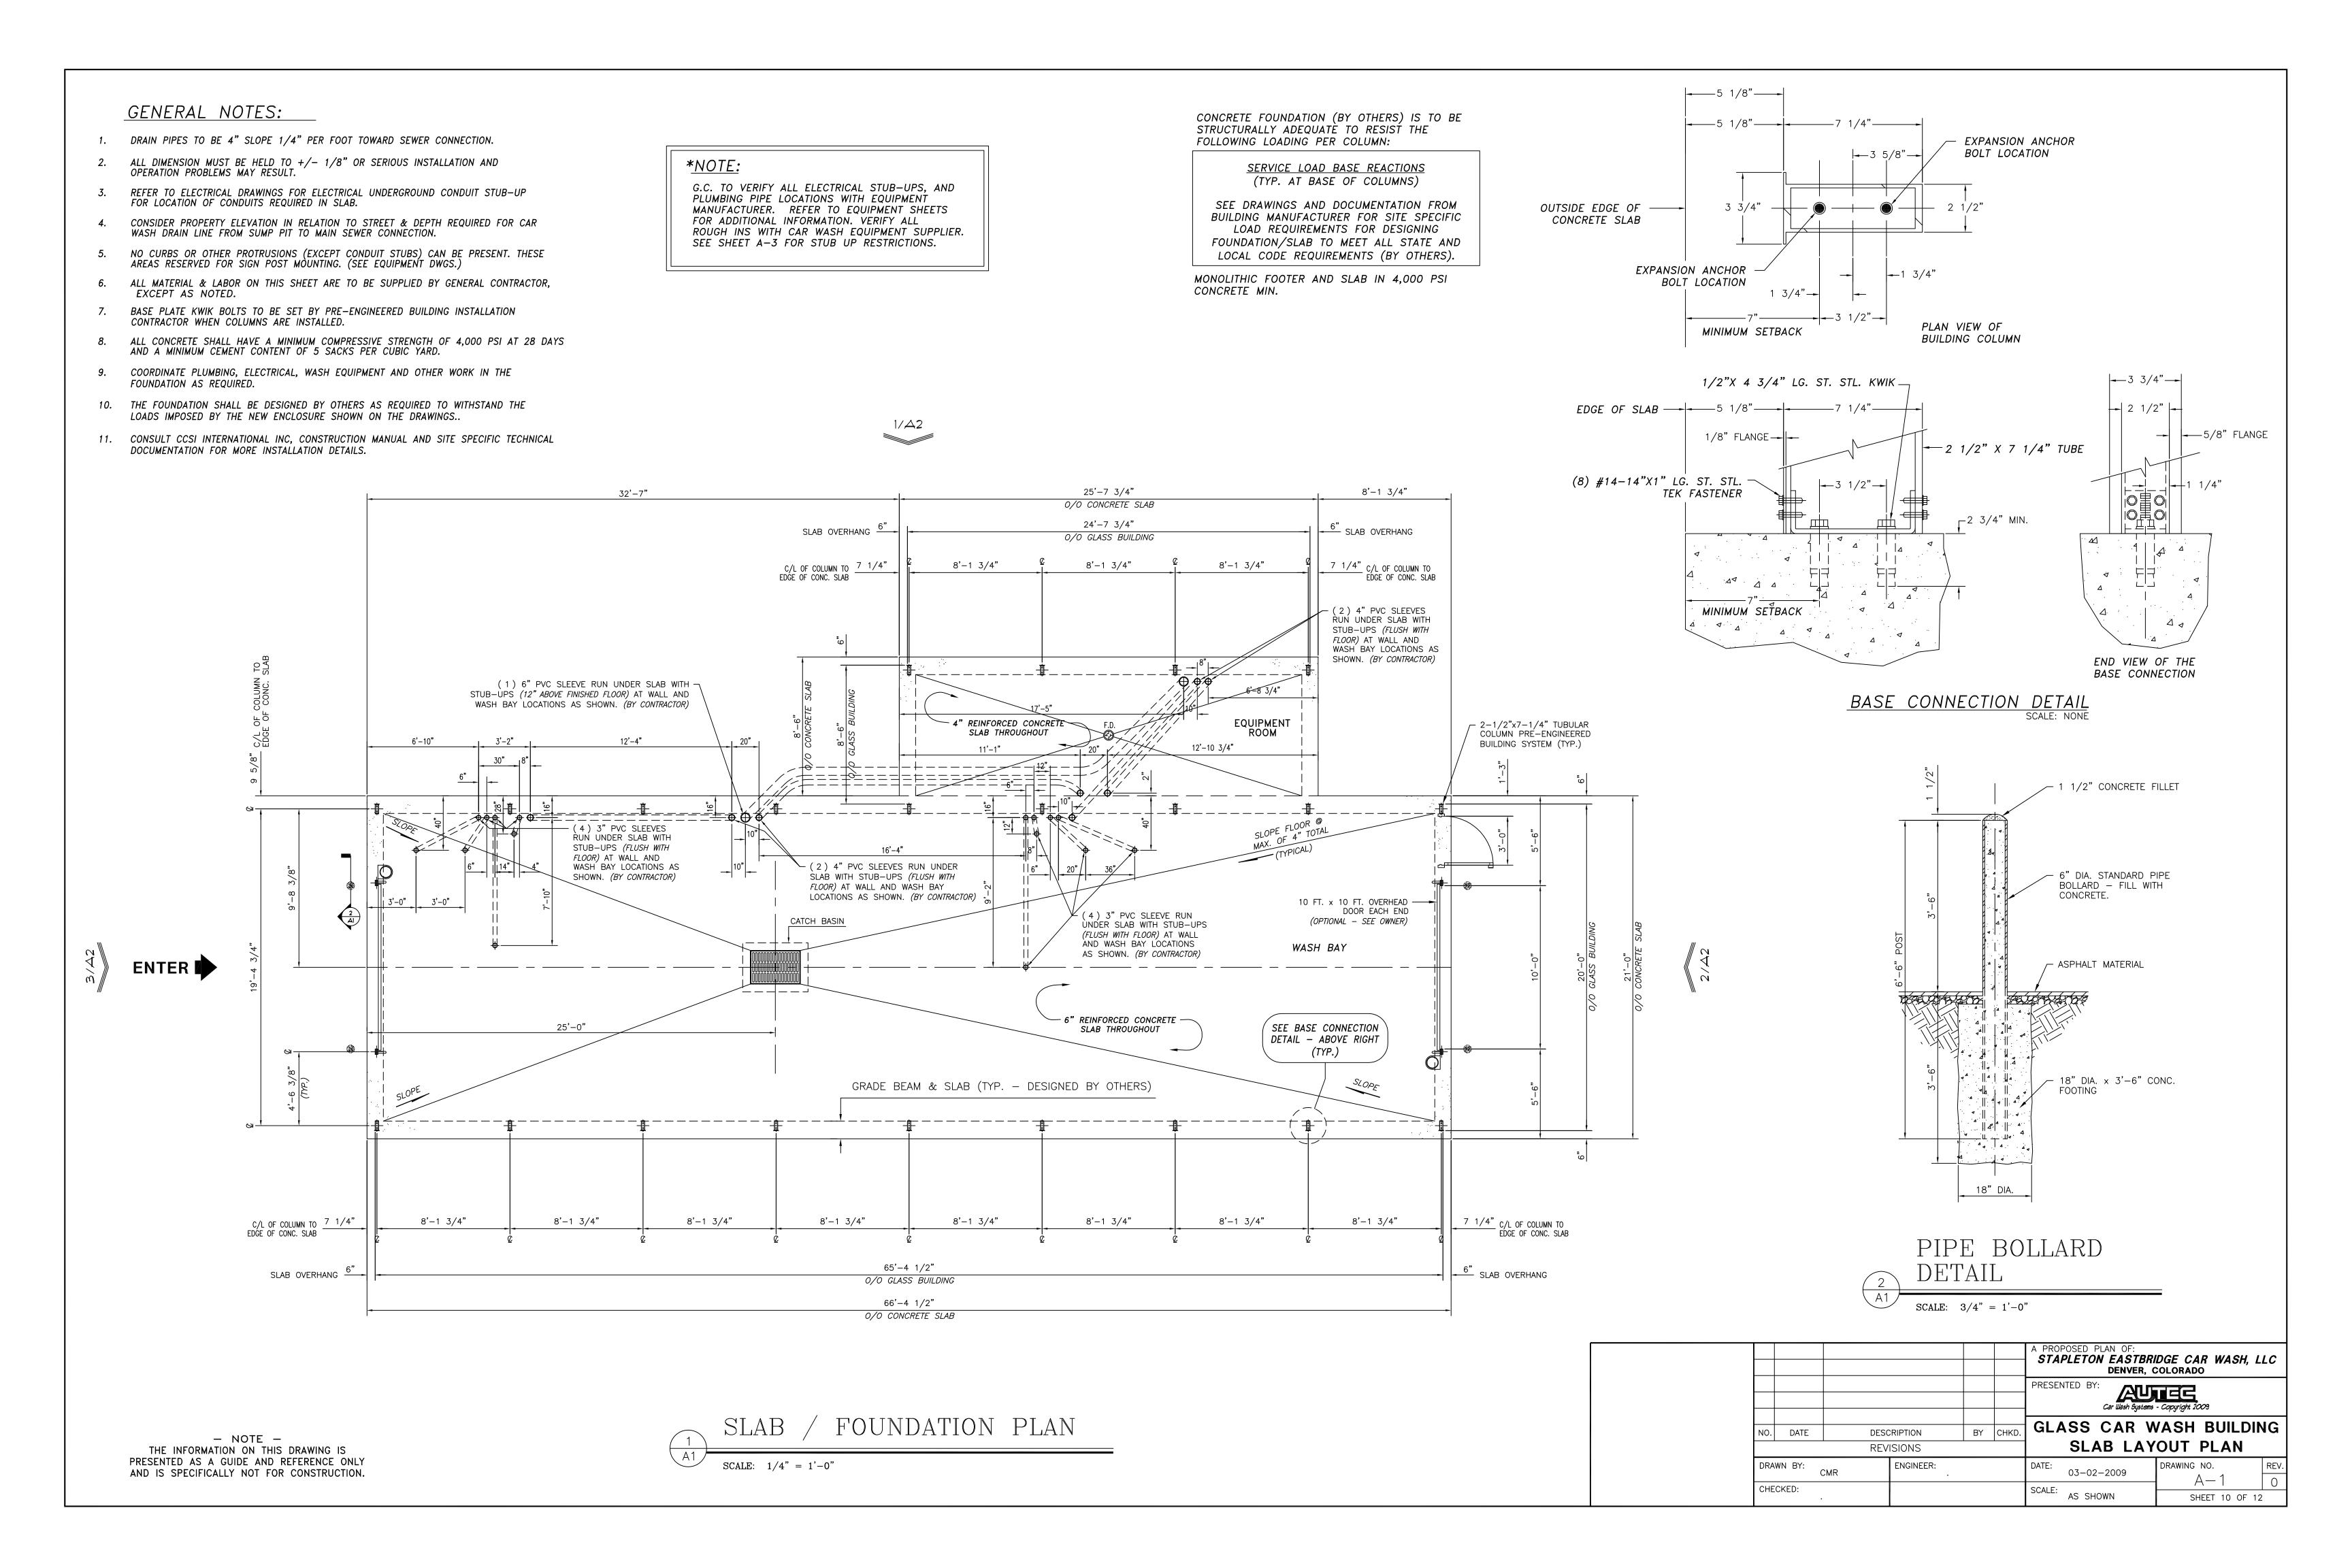


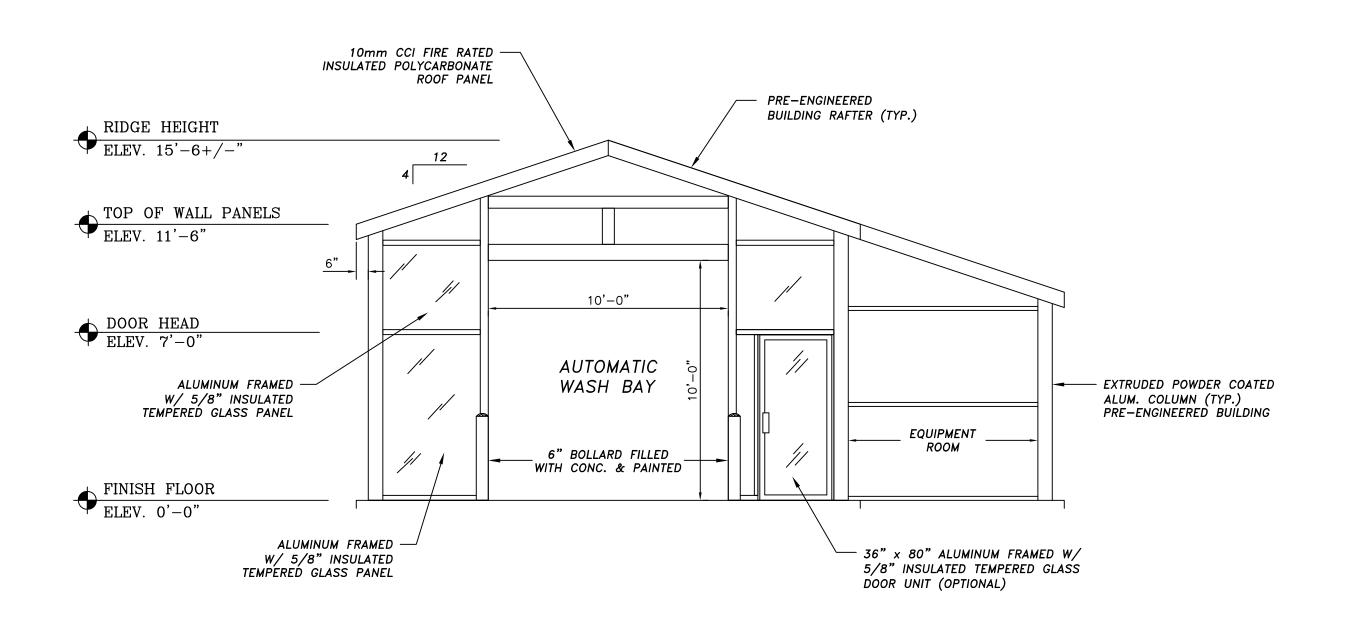

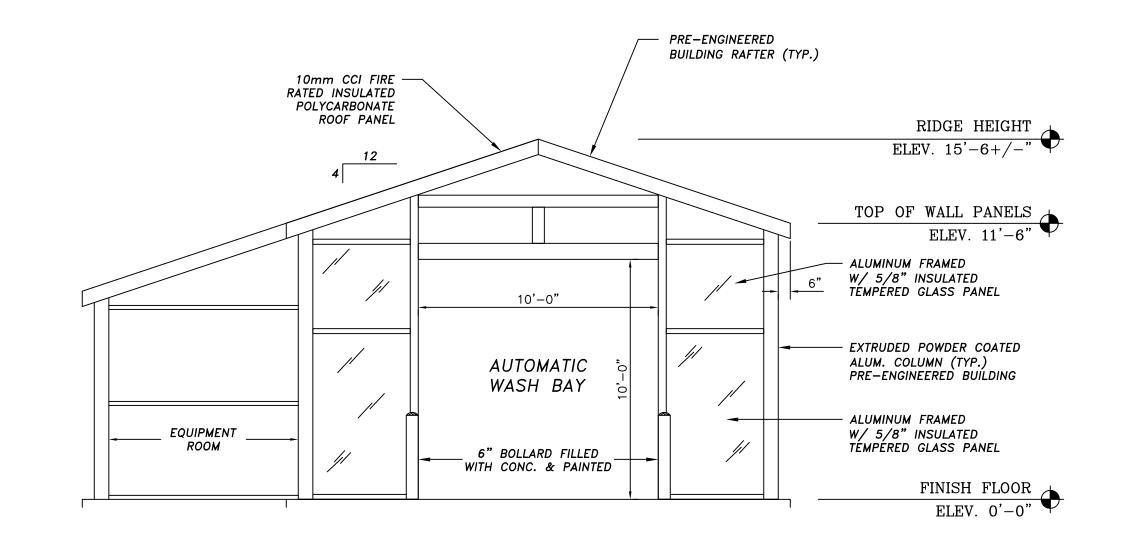





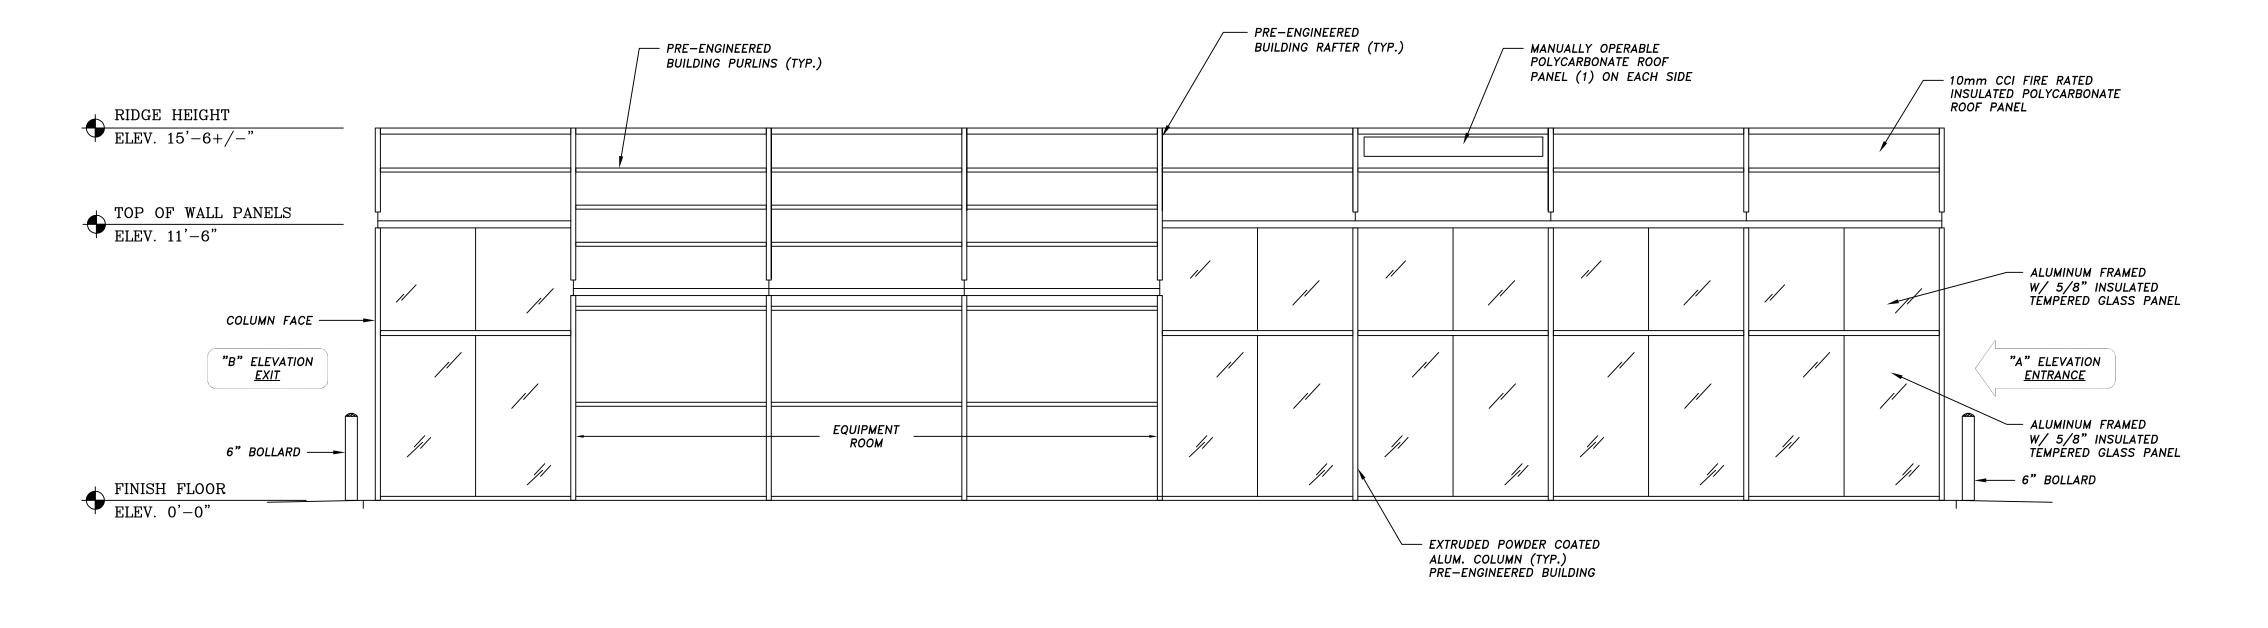



A PROPOSED PLAN OF:

STAPLETON EASTBRIDGE CAR WASH, LLC

DENVER, COLORADO

PRESENTED BY:

Car Wash Systems - Copyright 2009

GLASS CAR WASH BUILDING

REVISIONS

DRAWN BY:
CMR
ENGINEER:


DATE:
03-02-2009

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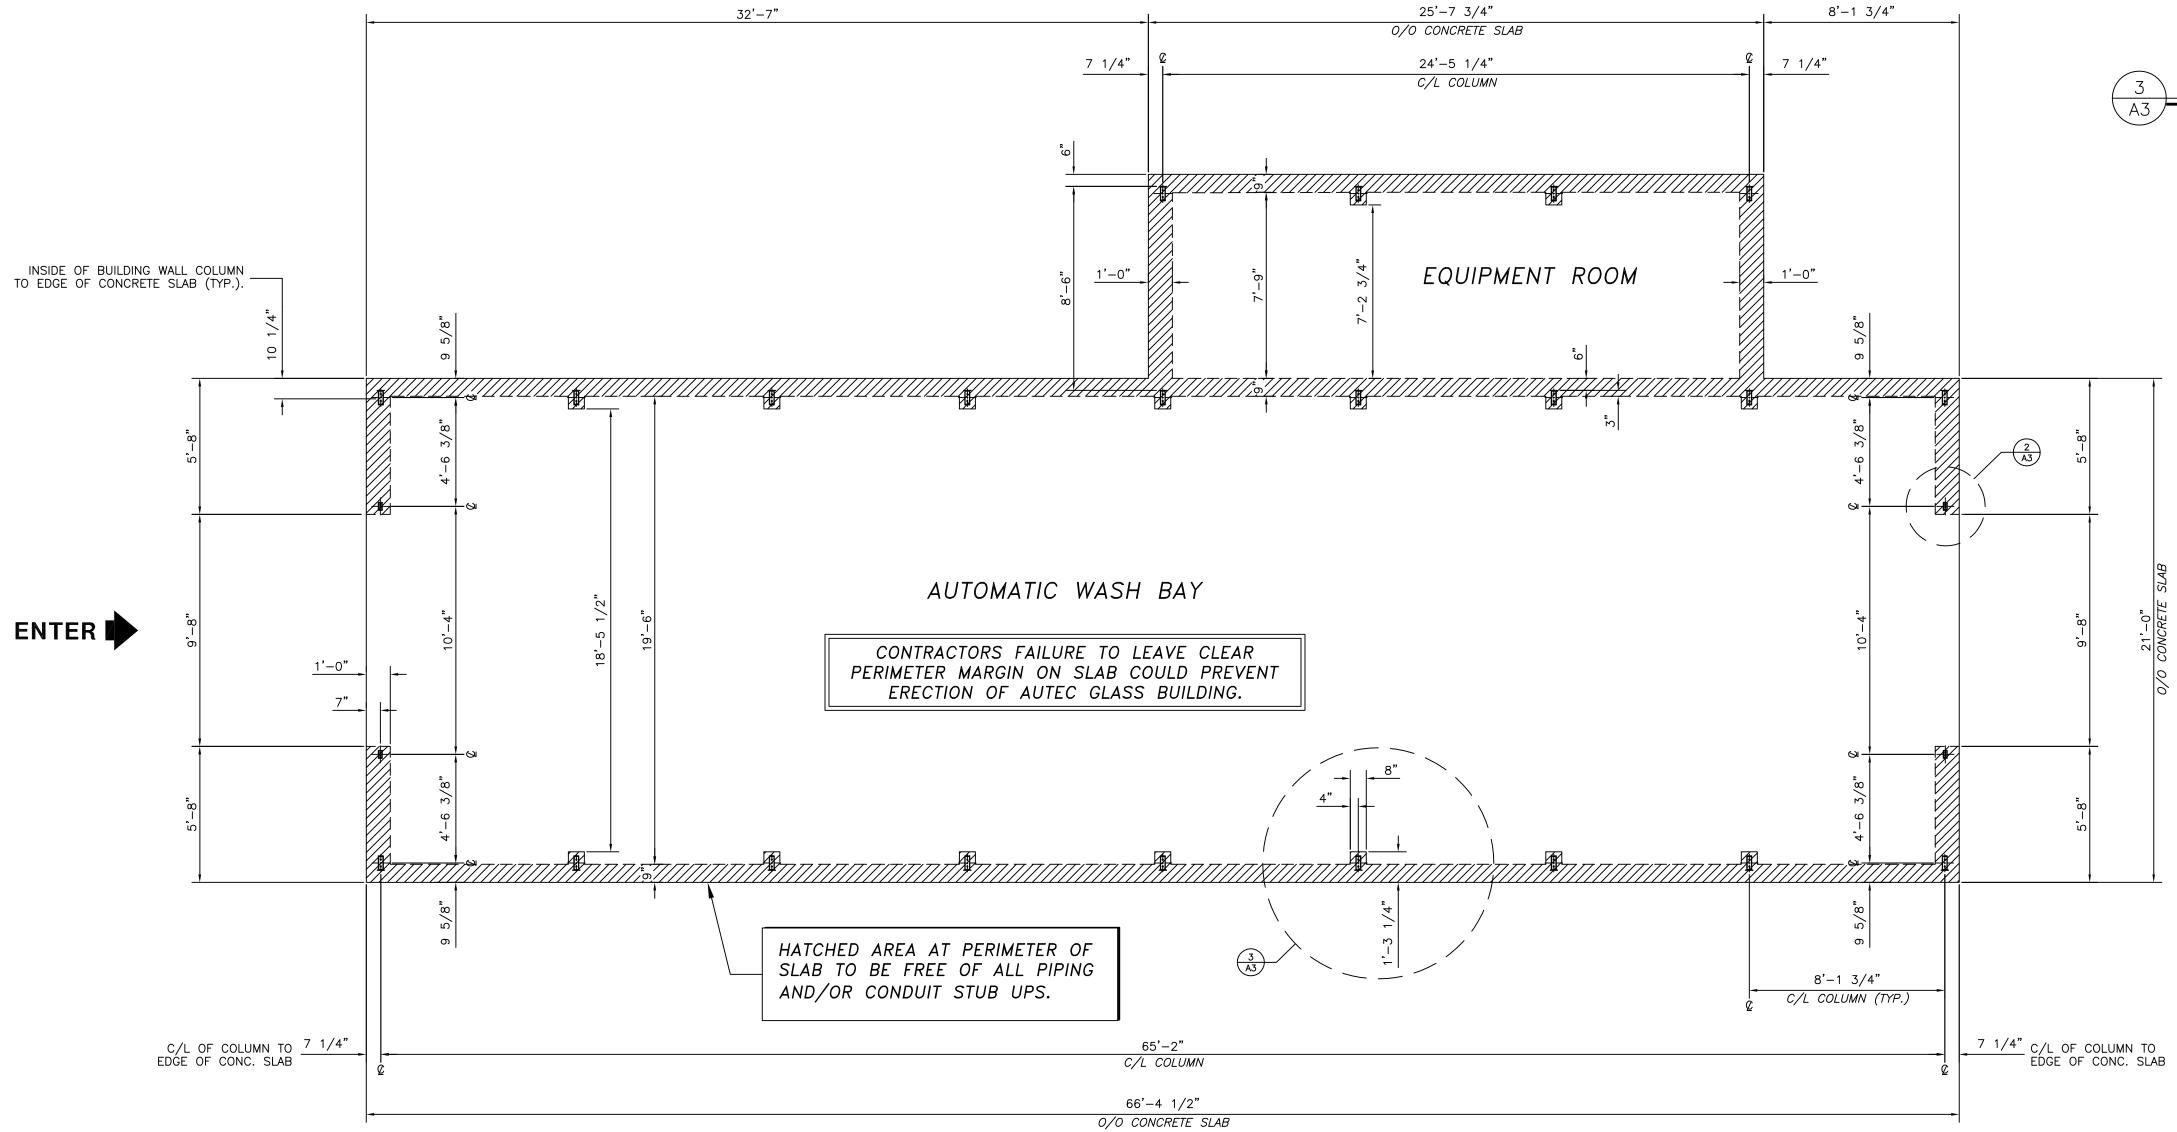
SHEET 11 OF 12

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TYPICAL COLUMN AT DOORWAY

SCALE: NONE

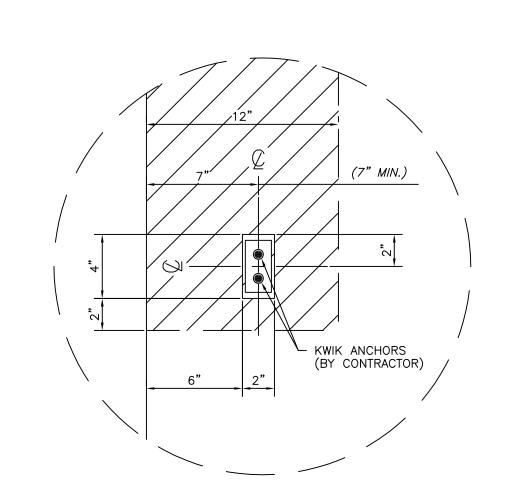

STUB-UP RESTRICTION LAYOUT

A3

SCALE: 1/4" = 1'-0"

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						PRESENTED BY: Car Wash Systems - Copyright 2009	
NO.	DATE	DESC	RIPTION	BY	CHKD.	GLASS CAR WASH BUILDING	-
		REV	SIONS		I .	STUB-UP RESTRICTIONS LAYOUT	
DRAV	WN BY:	CMR	ENGINEER:			DATE: 03-02-2009 DRAWING NO. REV	_
CHE	CKED:					SCALE: AS SHOWN SHEET 12 OF 12	_


F EDGE OF CONCRETE SLAB

/ KWIK ANCHORS (BY CONTRACTOR)

TYPICAL BUILDING COLUMN

SCALE: NONE

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EQUIPMENT LAYOUT PLAN SCALE: 1/4" = 1'-0"

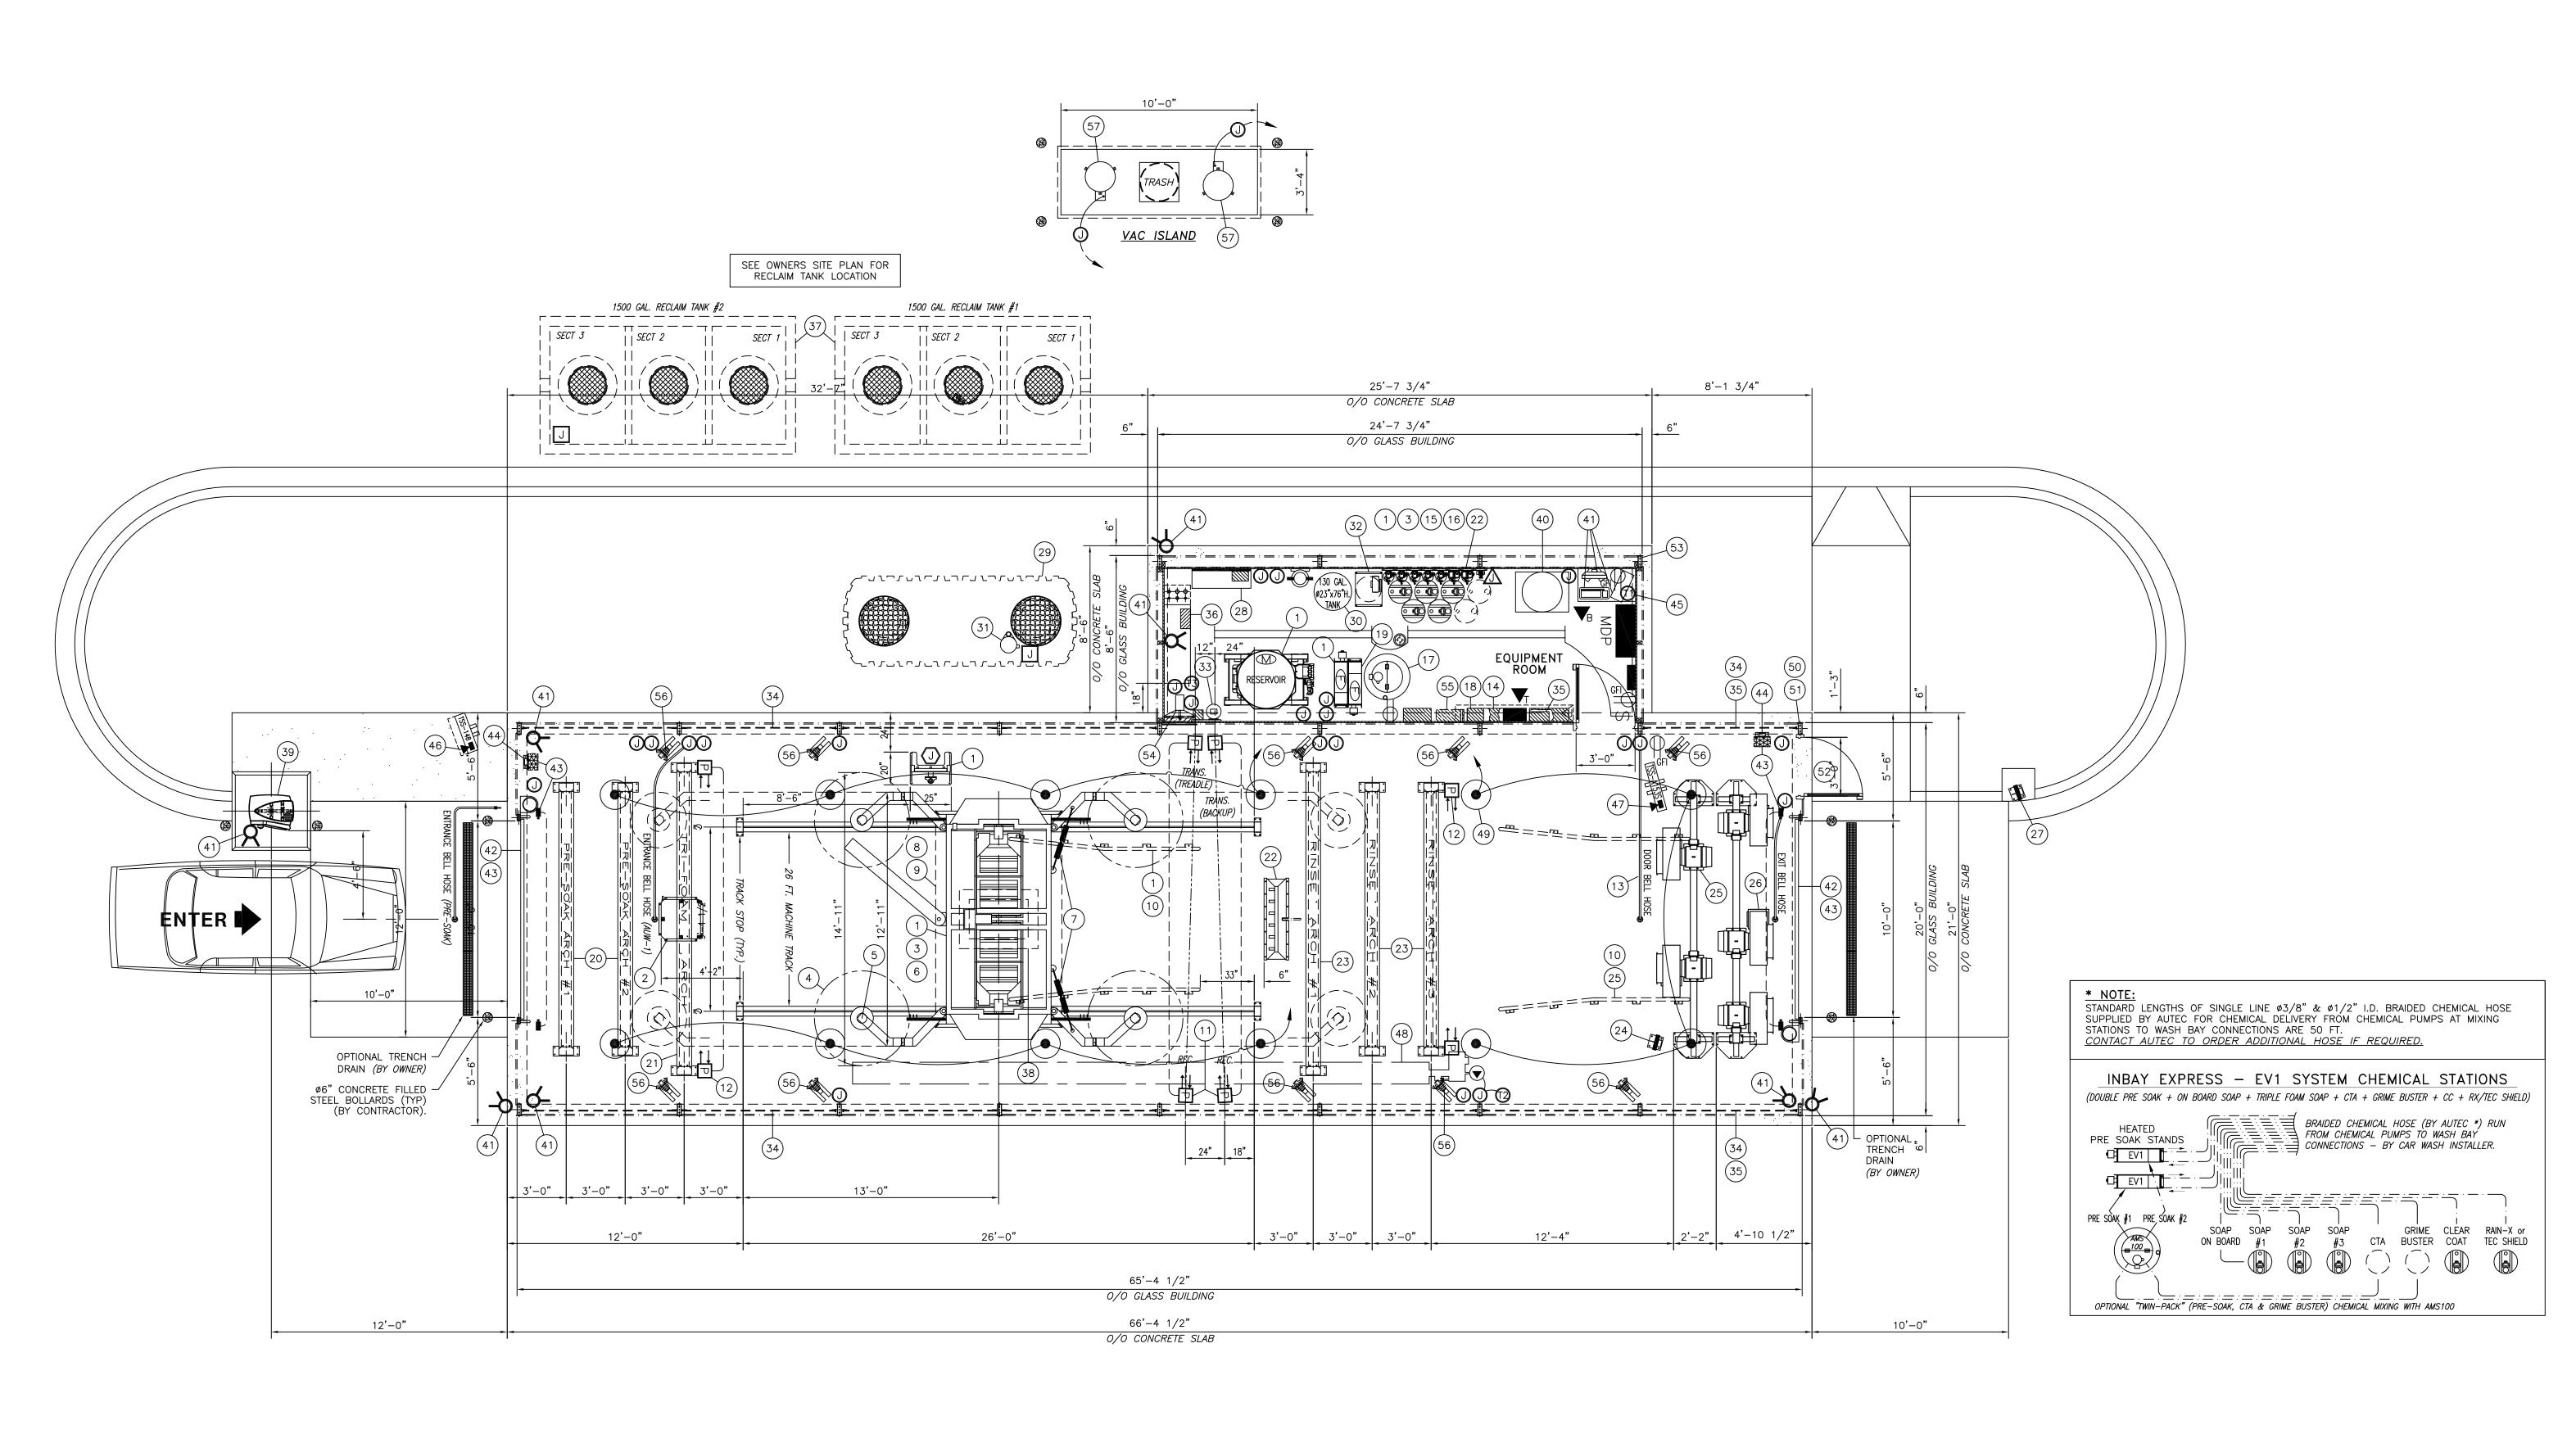GENERAL NOTES:


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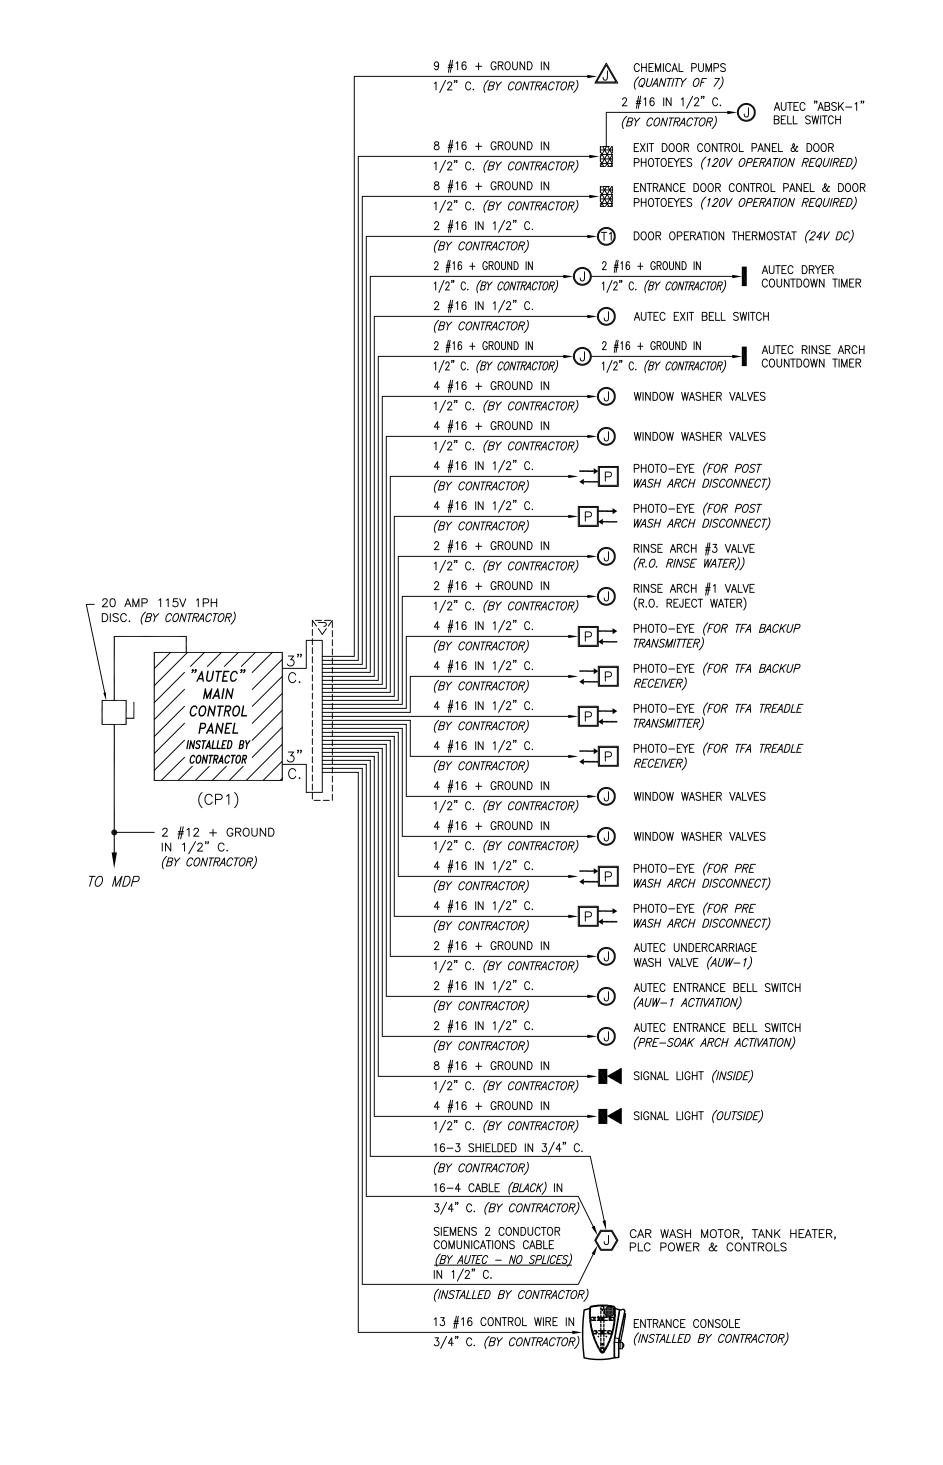
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									DGE CAR WASH, LL	. c
-							PRESEN	TED BY: Car Wash Systems	Copyright 2009	
	NO.	DATE	DATE DESCRIPTION BY CHKD. REVISIONS					EQUIPMEN PL		
		VN BY:	CMR	ENGINEER: .			DATE:	03-02-2009	DRAWING NO. EV1-0144	REV.
	CHEC	JNED;	•				SCALE: AS SHOWN		SHEET 2 OF 12	






ELECTRICAL LOAD TABLE

ITEM	OLIANITITY	LID	SUGGESTED BR	REAKER SIZE *	DUACE	DEMARKS
ITEM	QUANTITY	HP	208/230V	460V	PHASE	REMARKS
CARWASH MOTOR	1	10	50 AMP	25 AMP	3 PH	
EV1 PUMP SYSTEM	1	20	80 AMP	40 AMP	3 PH	
DBL. CHEM. STAND	2	1	100 AMP	50 AMP	3 PH	(INCLUDES 2 TANK HEATERS)
BLOWER MOTORS	3	15	175 AMP	80 AMP	3 PH	
BLOWER MOTORS	2	15	125 AMP	60 AMP	3 PH	
RECLAIM MOTOR	1	5	30 AMP	15 AMP	3 PH	
R. O. PUMP	1	1.5	20 AMP		1 PH	
R. O. REPRESSURIZATION	1	3	20 AMP		1 PH	
REJECT REPRESSURIZATION	1	3	20 AMP		1 PH	
AIR COMPRESSOR	1	5	20 AMP	10 AMP	3 PH	

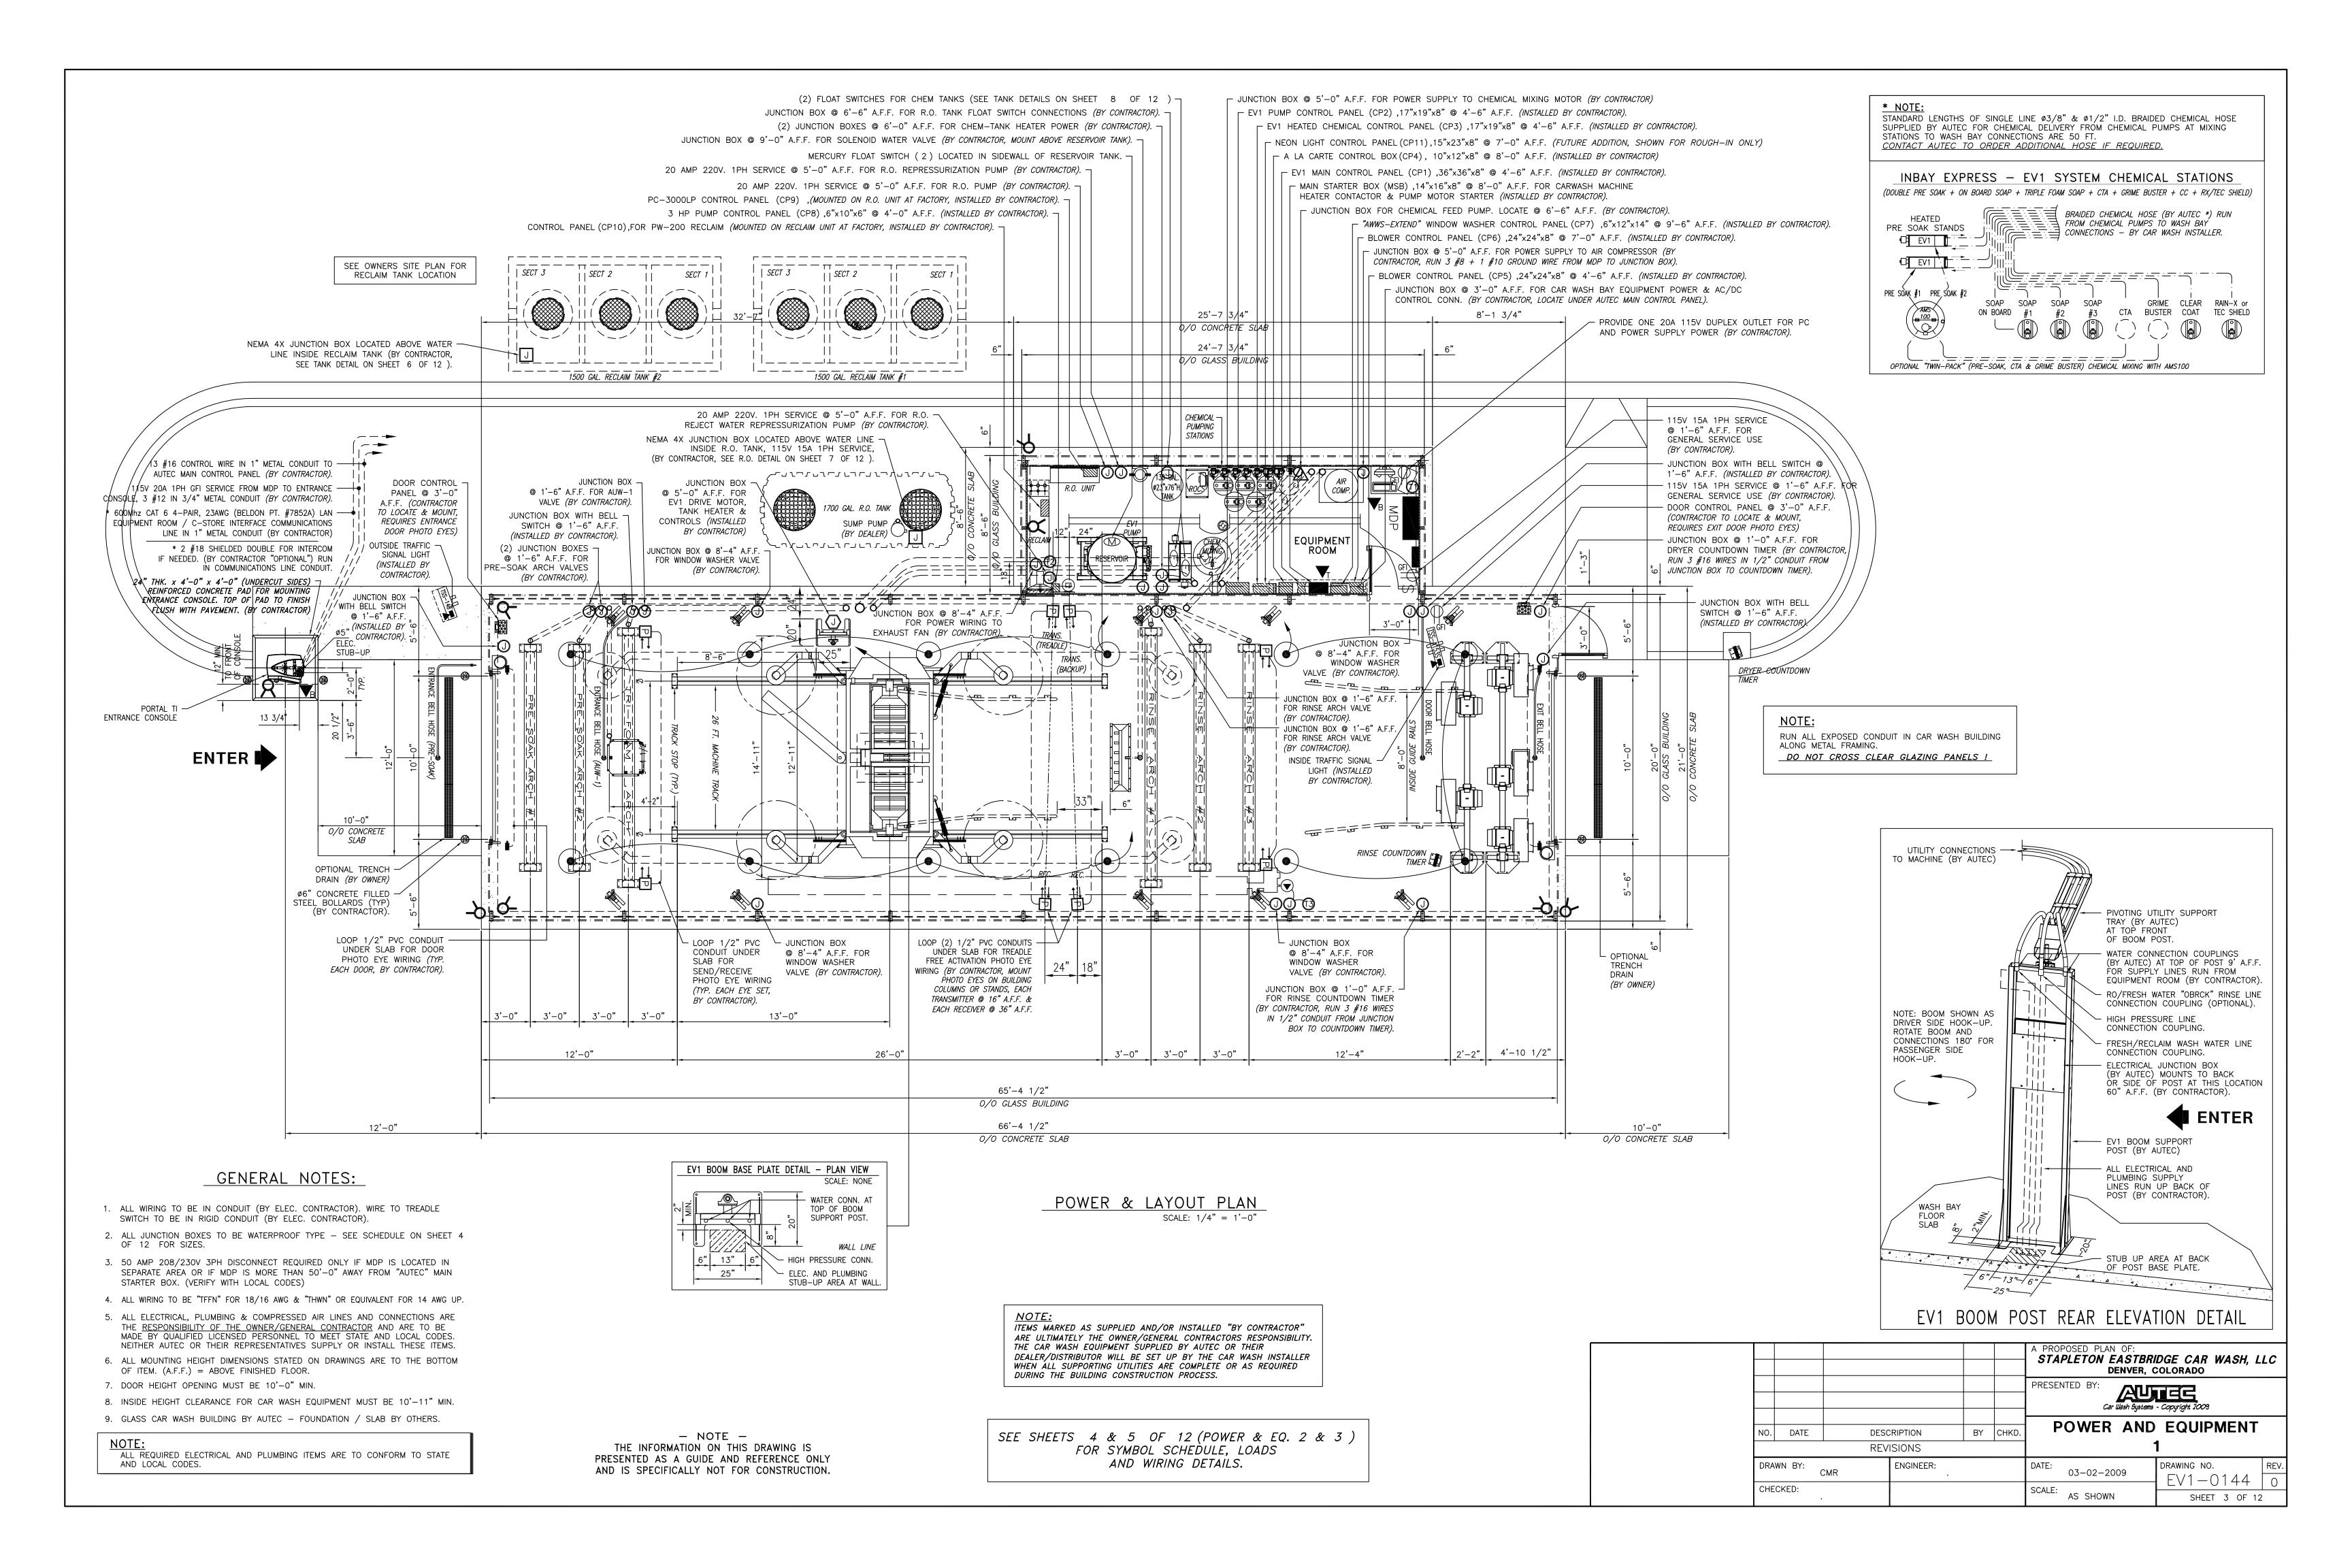ITEM	QUANTITY	VOLTS/AMPS	PHASE	REMARKS
ENTRANCE CONSOLE	1	115V 20 AMP	1 PH	(GFI CIRCUIT REQUIRED)
SERVICE OUTLET	2	115V 15 AMP	1 PH	(GFI CIRCUIT REQUIRED)
MAIN CONTROL PANEL	1	115V 20 AMP	1 PH	
RECLAIM CONTROL	1	115V 20 AMP	1 PH	
1/2 HP S/S SUMP PUMP	1	115V 15 AMP	1 PH	(VERIFY WITH DEALER)
EXHAUST FAN	1	115V 15 AMP	1 PH	
VIDEO / PC	1	115V 20 AMP	1 PH	
1/3 HP MIXING MOTOR	1	115V 15 AMP	1 PH	(PRE-SOAK CHEM TANK)
BAY LIGHTS (4) 400W	1	115V 20 AMP	1 PH	
BAY LIGHTS (4) 400W	1	115V 20 AMP	1 PH	
BAY LIGHTS (4) 400W	1	115V 20 AMP	1 PH	
BAY HEATER CONTROL	1	115V 15 AMP	1 PH	
EQUIPMENT ROOM LIGHTS	1	115V 20 AMP	1 PH	
NLCB-SX LIGHT PANEL	1	115V 60 AMP	1 PH	(FUTURE ADDITION)
CAR VACUUM	1	115V 25 AMP	1 PH	(VERIFY WITH DEALER)
CAR VACUUM	1	115V 25 AMP	1 PH	(VERIFY WITH DEALER)

^{*} THESE ARE SUGGESTED BREAKER SIZES BASED ON TYPICALLY USED EQUIPMENT. VERIFY EQUIPMENT LOAD REQUIREMENTS WITH ACTUAL EQUIPMENT USED. SIZE ELECTRICAL SERVICE

NOTE: SEE OWNER FOR AREA LIGHTING & ALL OTHER EQUIPMENT LOADES REQUIRED AT SITE

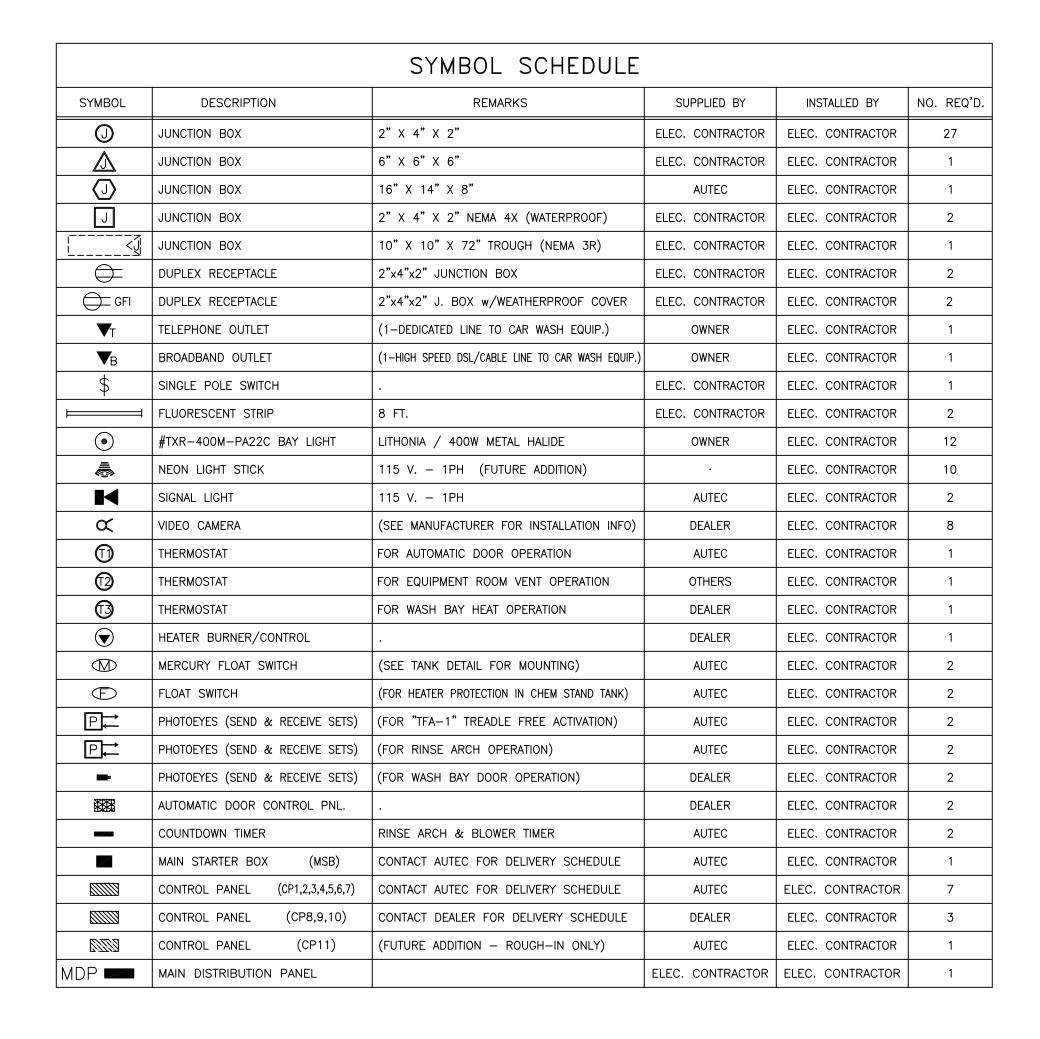

— 3 #0000 + GROUND

IN 2 1/2" C.

(BY CONTRACTOR)

REVISIONS


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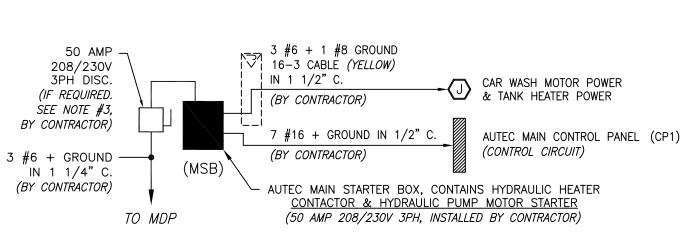
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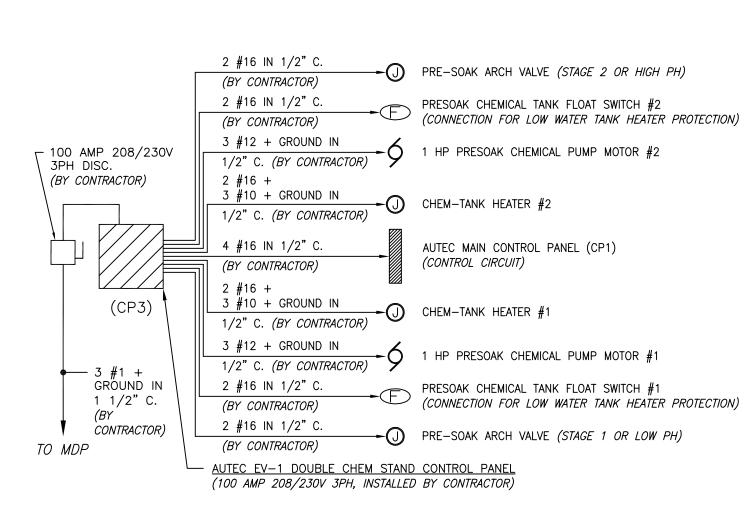
ENGINEER:


(BY CONTRACTOR)

TO MDP





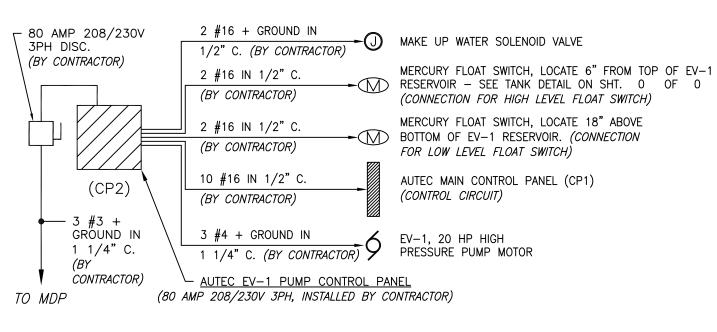

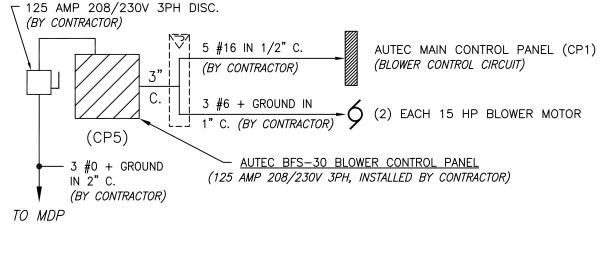

√ į 5 #16 IN 1/2" C.

(BY CONTRACTOR)

AUTEC MAIN CONTROL PANEL (CP1)

DRAWING NO.

EV1 - 0144 0

SHEET 4 OF 12

03-02-2009


SCALE: AS SHOWN

(BLOWER CONTROL CIRCUIT)

1" C. (BY CONTRACTOR)

- AUTEC BFS-45 BLOWER CONTROL PANEL

(175 AMP 208/230V 3PH, INSTALLED BY CONTRACTOR)

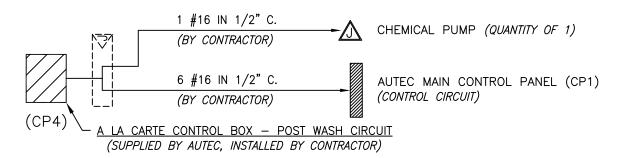

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					PRESENTED BY: Car Wash Systems - Copyright 2009
NO.	DATE	DESCRIPTION	BY	CHKD.	POWER AND EQUIPMENT

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NOTE —

CIRCUIT DIAGRAMS

GENERAL NOTES:


- 1. ALL WIRING TO BE IN CONDUIT (BY ELEC. CONTRACTOR). WIRE TO TREADLE SWITCH TO BE IN RIGID CONDUIT (BY ELEC. CONTRACTOR).
- 2. ALL JUNCTION BOXES TO BE WATERPROOF TYPE SEE SCHEDULE FOR SIZES.
- 3. 50 AMP 208/230V 3PH DISCONNECT REQUIRED ONLY IF MDP IS LOCATED IN SEPARATE AREA OR IF MDP IS MORE THAN 50'-0" AWAY FROM "AUTEC" MAIN STARTER BOX. (VERIFY WITH LOCAL CODES)
- 4. ALL WIRING TO BE "TFFN" FOR 18/16 AWG & "THWN" OR EQUIVALENT FOR 14 AWG UP.
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- 6. ALL MOUNTING HEIGHT DIMENSIONS STATED ON DRAWINGS ARE TO THE BOTTOM OF ITEM. (A.F.F.) = ABOVE FINISHED FLOOR.
- 8. INSIDE HEIGHT CLEARANCE FOR CAR WASH EQUIPMENT MUST BE 10'-11" MIN.


7. DOOR HEIGHT OPENING MUST BE 10'-0" MIN.


9. GLASS CAR WASH BUILDING BY AUTEC - FOUNDATION / SLAB BY OTHERS.

ALL REQUIRED ELECTRICAL AND PLUMBING ITEMS ARE TO CONFORM TO STATE AND LOCAL CODES.


(CONTRACTOR TO SUPPLY ALL WIRING RUNS IN CONDUIT TO AND FROM CONTROL PANELS)

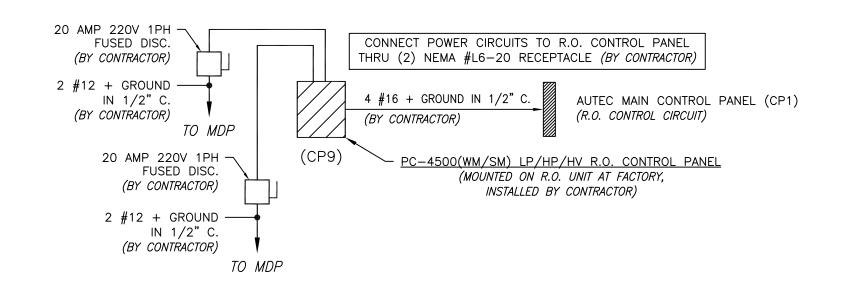


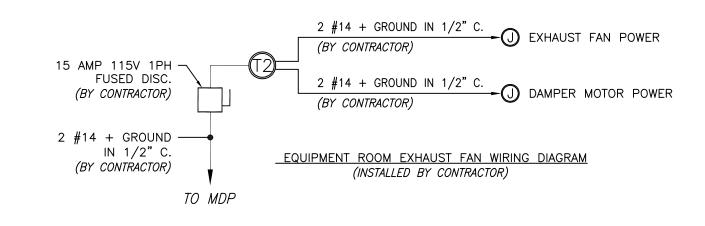


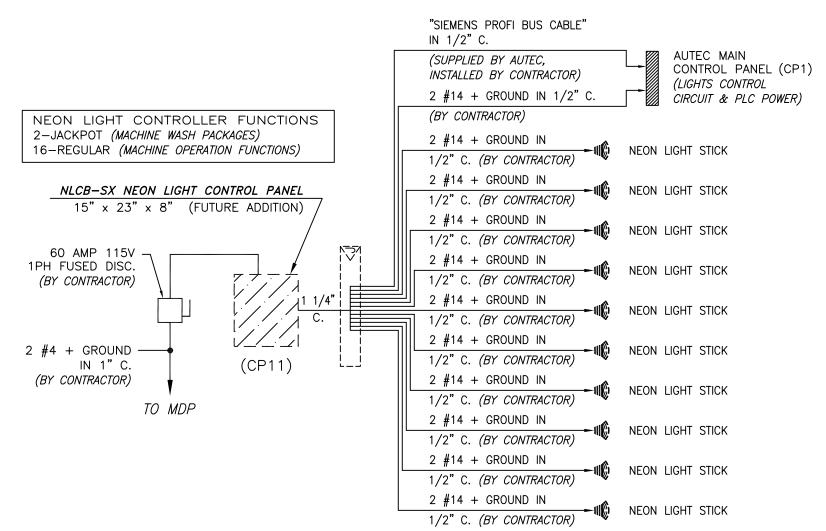


NLCB—SX NEON LIGHT CONTROL PANEL — SHOWN FOR ROUGH—IN ONLY!
— OPTIONAL FUTURE ADDITION —

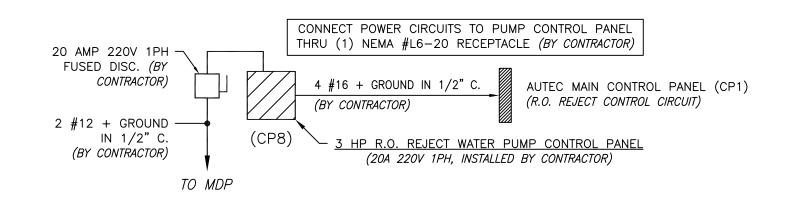

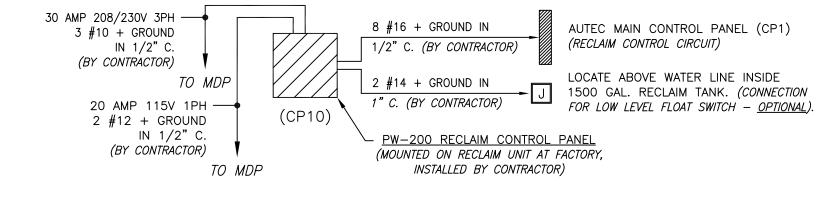

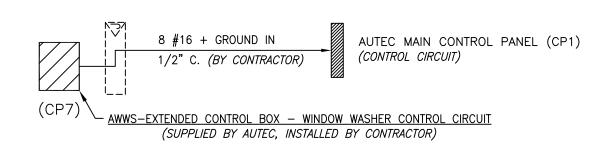

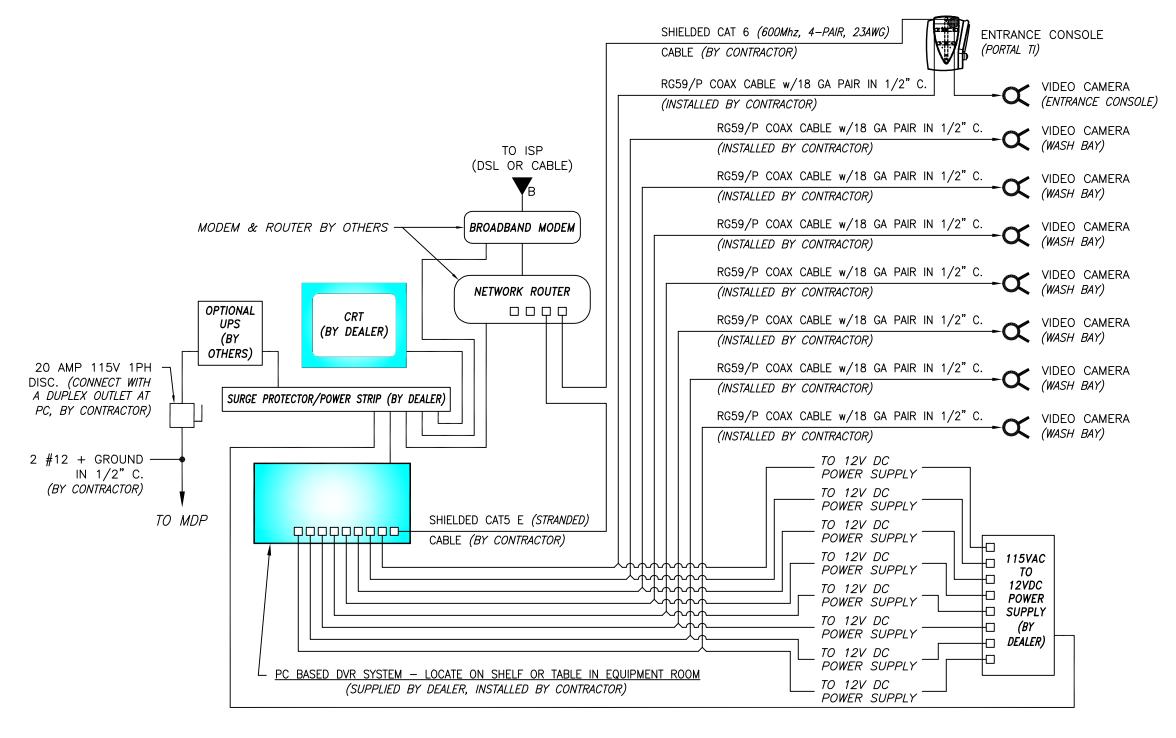


- 1. ALL WIRING TO BE IN CONDUIT (BY ELEC. CONTRACTOR). WIRE TO TREADLE SWITCH TO BE IN RIGID CONDUIT (BY ELEC. CONTRACTOR).
- 2. ALL JUNCTION BOXES TO BE WATERPROOF TYPE SEE SCHEDULE ON SHEET 4 OF 12 FOR SIZES.
- 3. 50 AMP 208/230V 3PH DISCONNECT REQUIRED ONLY IF MDP IS LOCATED IN SEPARATE AREA OR IF MDP IS MORE THAN 50'-0" AWAY FROM "AUTEC" MAIN STARTER BOX. (VERIFY WITH LOCAL CODES)
- 4. ALL WIRING TO BE "TFFN" FOR 18/16 AWG & "THWN" OR EQUIVALENT FOR 14 AWG UP.
- 5. ALL ELECTRICAL, PLUMBING & COMPRESSED AIR LINES AND CONNECTIONS ARE THE <u>RESPONSIBILITY OF THE OWNER/GENERAL CONTRACTOR</u> AND ARE TO BE MADE BY QUALIFIED LICENSED PERSONNEL TO MEET STATE AND LOCAL CODES. NEITHER AUTEC OR THEIR REPRESENTATIVES SUPPLY OR INSTALL THESE ITEMS.
- 6. ALL MOUNTING HEIGHT DIMENSIONS STATED ON DRAWINGS ARE TO THE BOTTOM OF ITEM. (A.F.F.) = ABOVE FINISHED FLOOR.
 7. DOOR HEIGHT OPENING MUST BE 10'-0" MIN.
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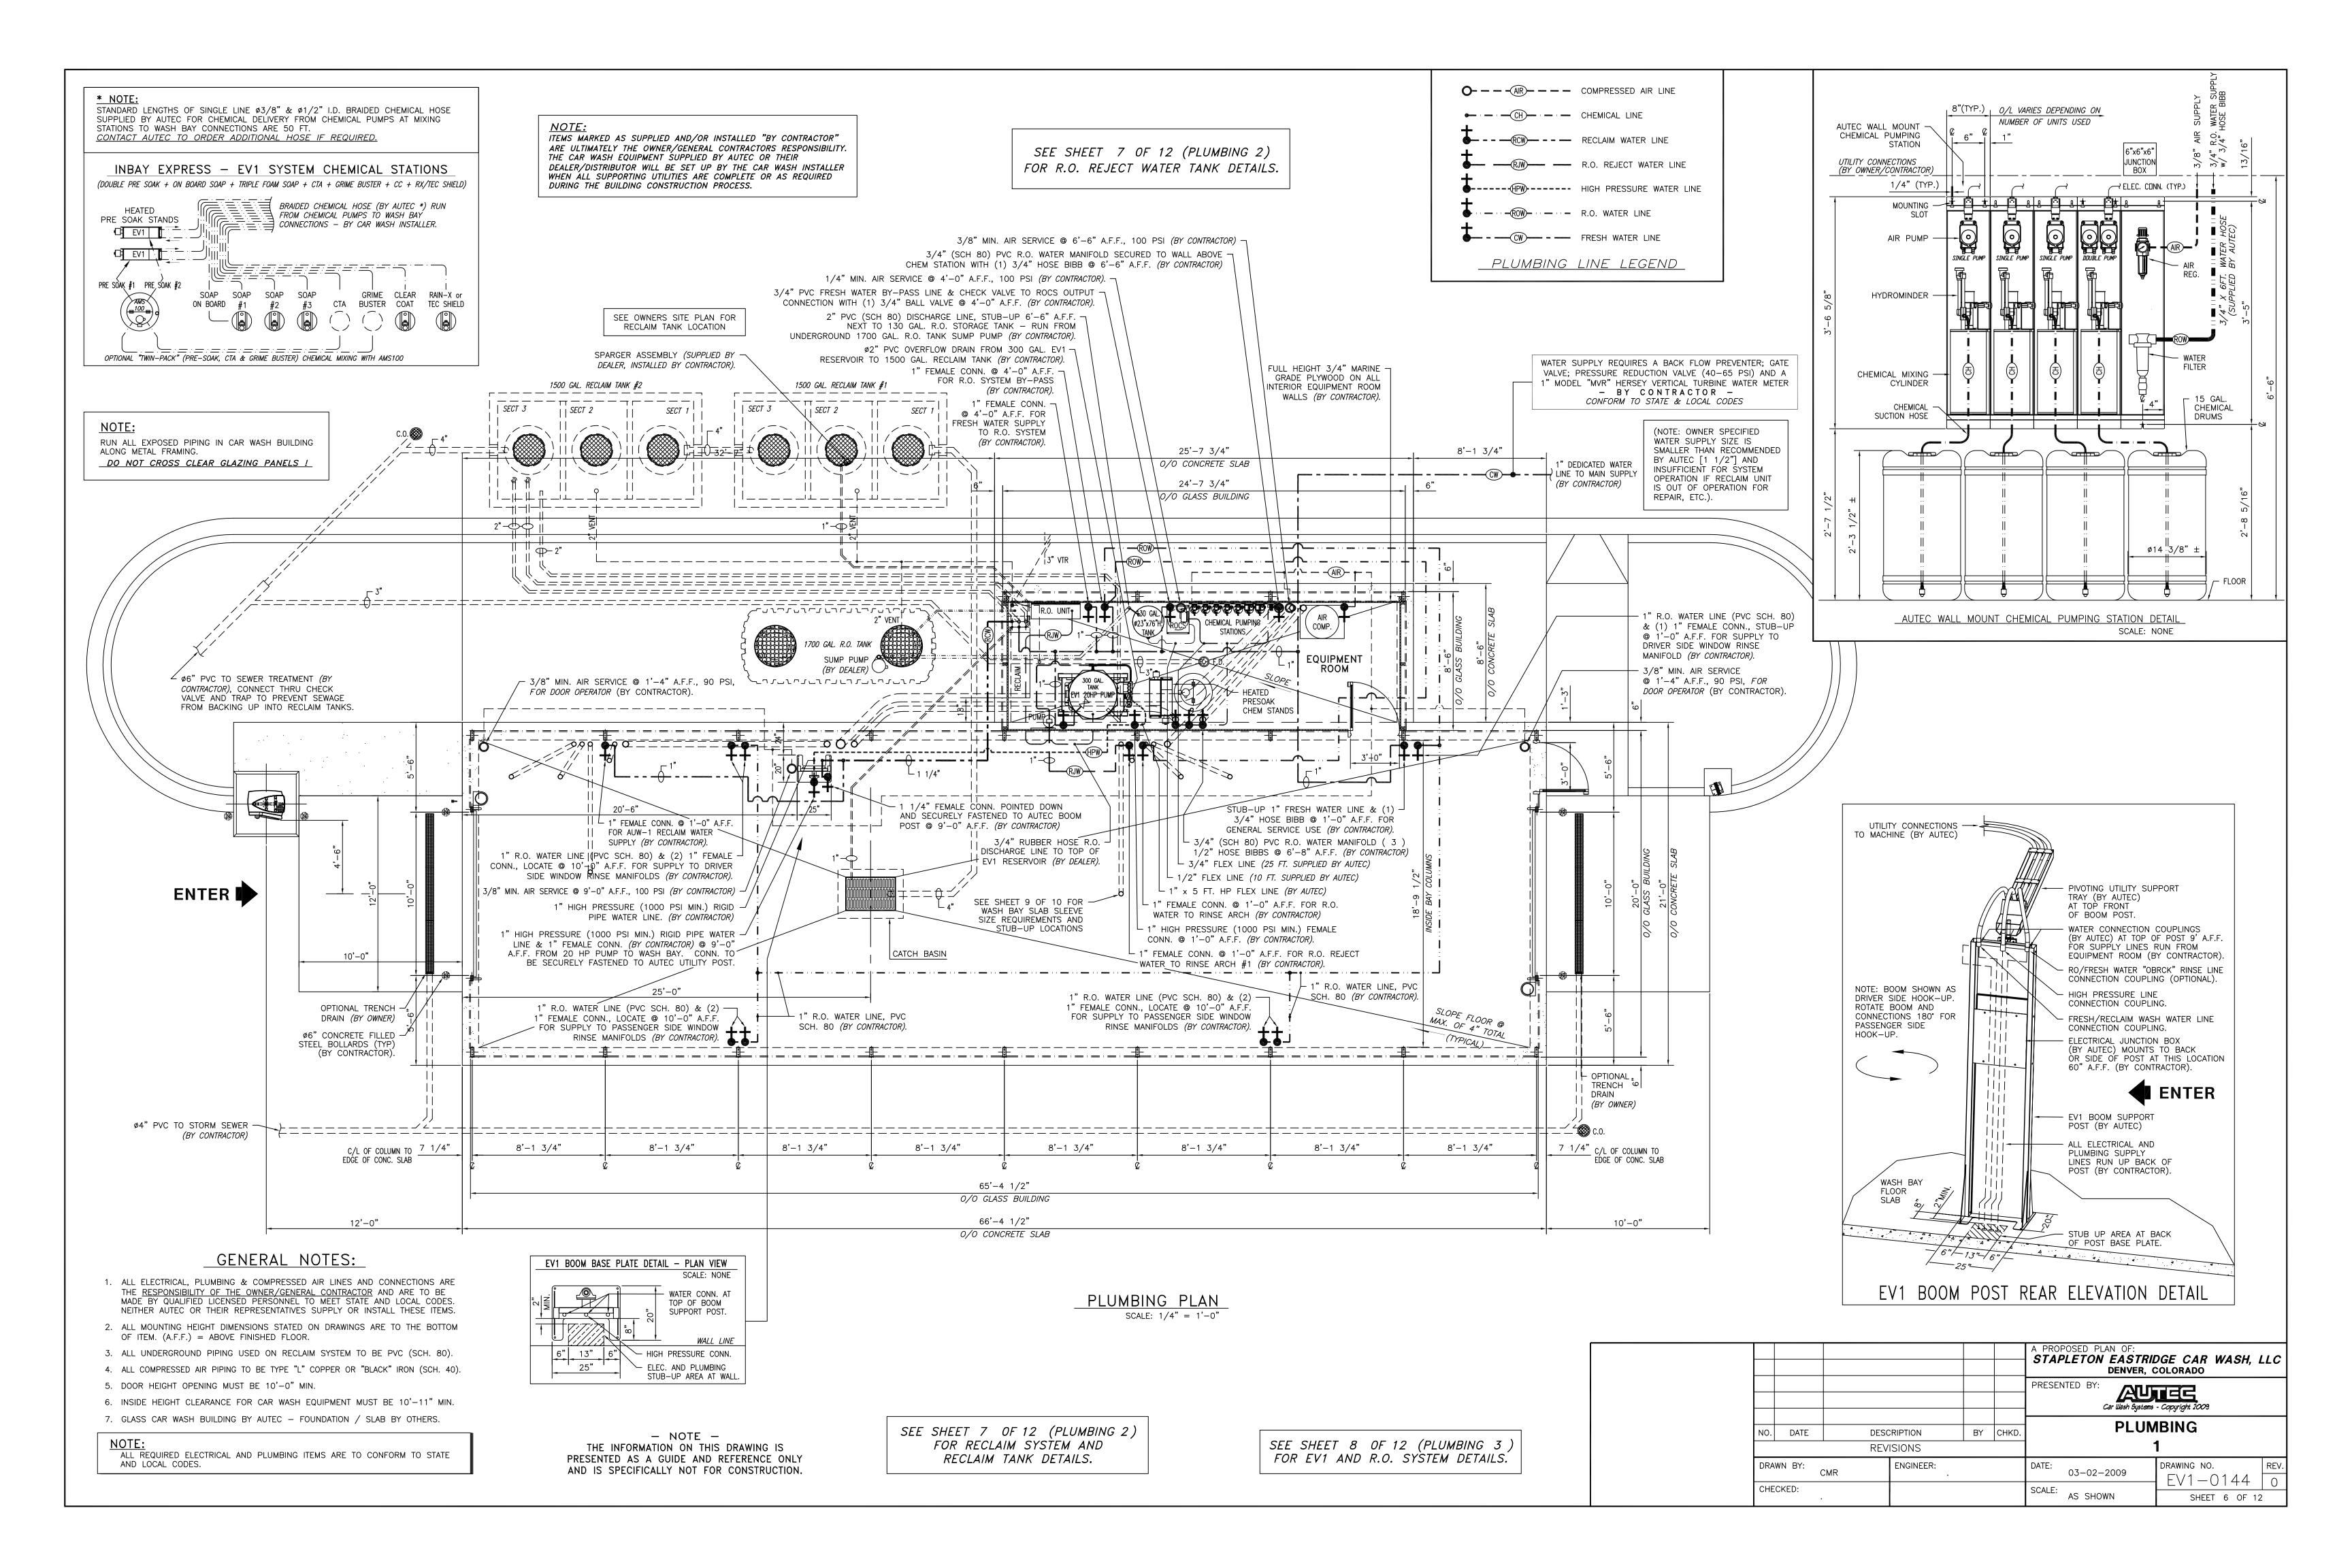
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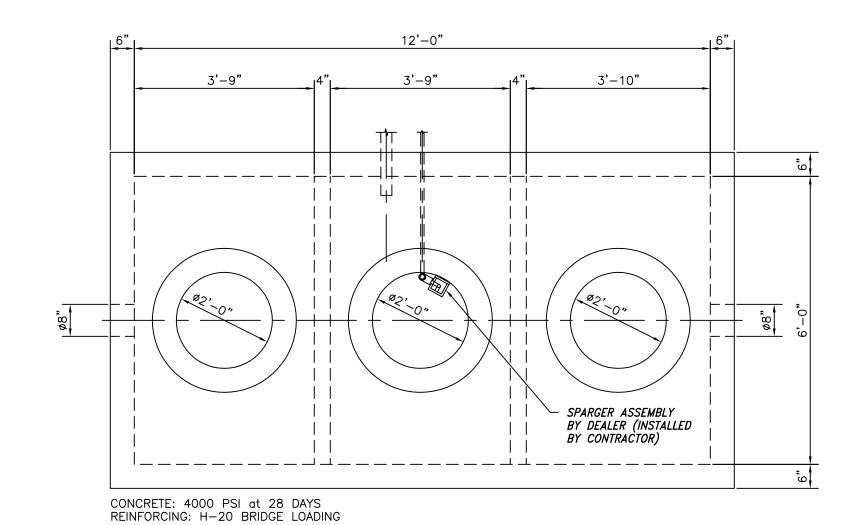
ALL REQUIRED ELECTRICAL AND PLUMBING ITEMS ARE TO CONFORM TO STATE
AND LOCAL CODES.


— NOTE —
THE INFORMATION ON THIS DRAWING IS
PRESENTED AS A GUIDE AND REFERENCE ONLY
AND IS SPECIFICALLY NOT FOR CONSTRUCTION.

CIRCUIT DIAGRAMS (CONTRACTOR TO SUPPLY ALL WIRING RUNS IN CONDUIT TO AND FROM CONTROL PANELS)






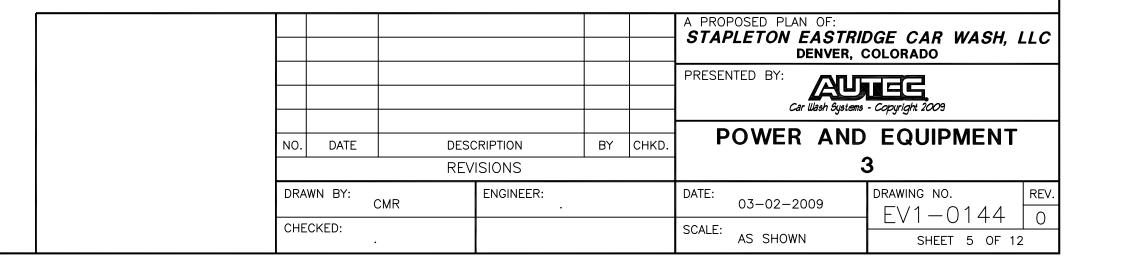


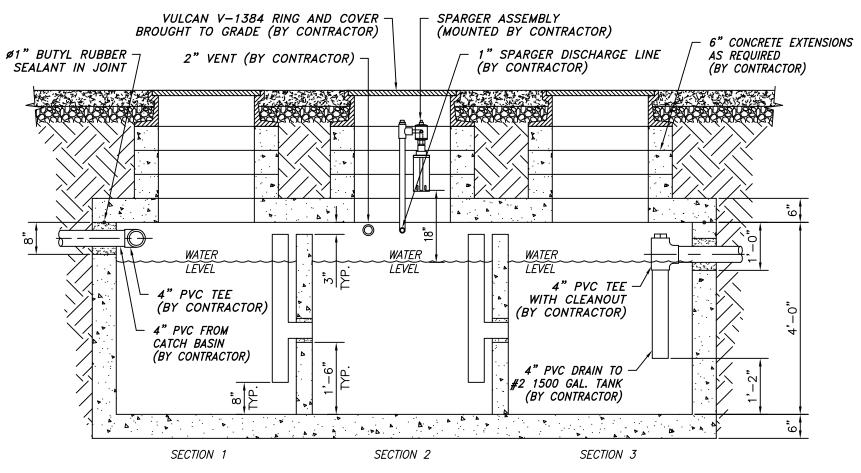

1500 GAL. RECLAIM TANK #1 - OIL/GREASE SEPARATOR DETAIL

SCALE: 1/2" = 1'-0"

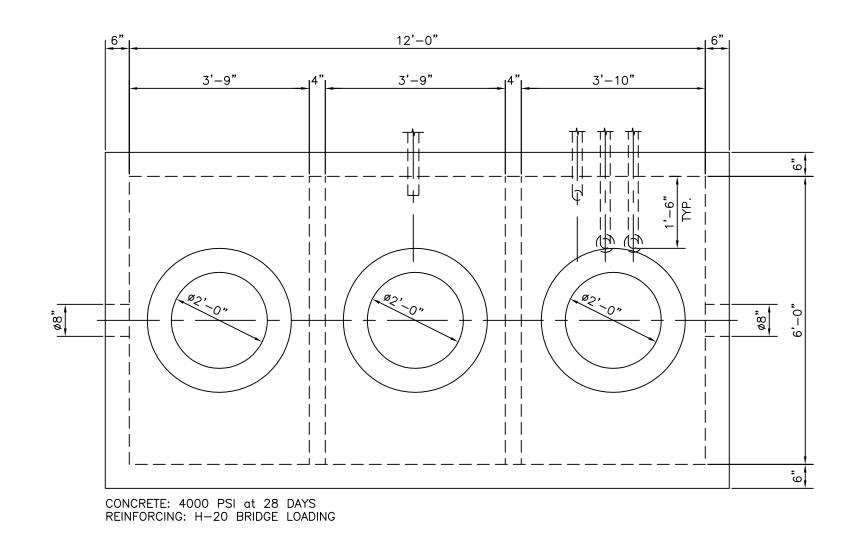

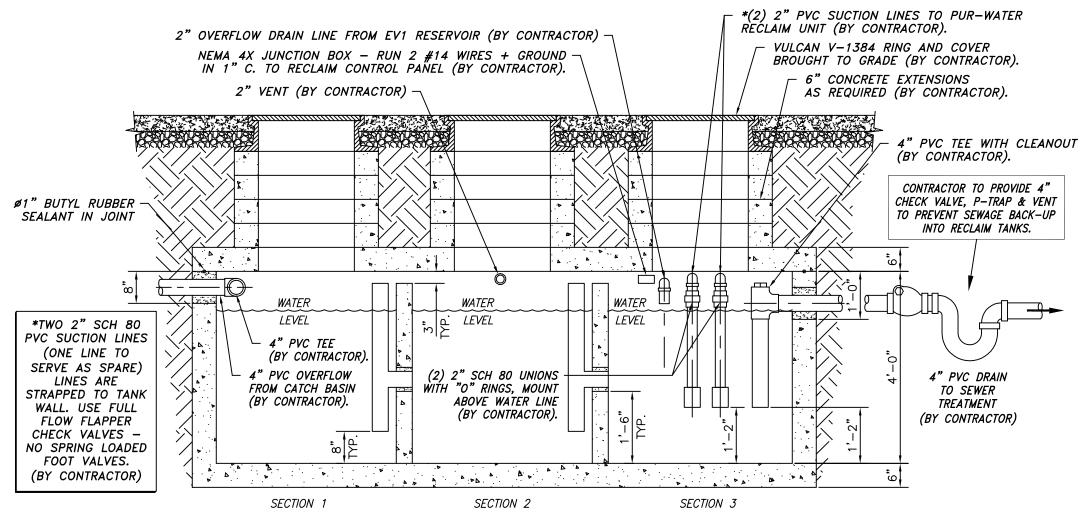



1500 GAL. RECLAIM TANK - OIL/GREASE SEPARATOR DETAIL

SCALE: 1/2" = 1'-0"

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- 2. ALL MOUNTING HEIGHT DIMENSIONS STATED ON DRAWINGS ARE TO THE BOTTOM OF ITEM. (A.F.F.) = ABOVE FINISHED FLOOR.
- 3. ALL UNDERGROUND PIPING USED ON RECLAIM SYSTEM TO BE PVC (SCH. 80).
- 4. ALL COMPRESSED AIR PIPING TO BE TYPE "L" COPPER OR "BLACK" IRON (SCH. 40).
- 5. DOOR HEIGHT OPENING MUST BE 10'-0" MIN.
- 6. INSIDE HEIGHT CLEARANCE FOR CAR WASH EQUIPMENT MUST BE 10'-11" MIN.
- 7. GLASS CAR WASH BUILDING BY AUTEC FOUNDATION / SLAB BY OTHERS.

NOTE: ALL REQUIRED ELECTRICAL AND PLUMBING ITEMS ARE TO CONFORM TO STATE AND LOCAL CODES.

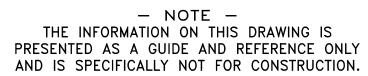

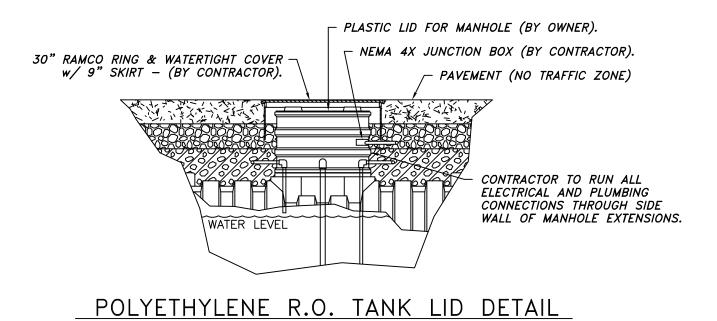

THIRDCCYCLONE DISCHARGE LINE FROM RECLAIM
(BY CONTRACTOR).

C.I. FRAME & GRATE BY OWNER BROUGHT
TO GRADE BY CONTRACTOR.

4" PVC TEE WITH CLEANOUT
(BY CONTRACTOR).

WATER

CONTRACTOR TO GROUT
WATER TIGHT (TYP.)

#4 @ 6"
EACH WAY

EACH WAY

EACH WAY

A"

CONTRACTOR TO GROUT

WATER TIGHT (TYP.)


CATCH BASIN DETAIL

SCALE: 3/4" = 1'-0"

- A 1 1/2" REDUCED TO 1 1/4" FILTERED WATER OUTLET LINE TO CAR WASH SUPPLY (BY CONTRACTOR)
- B 2" HYDROCYCLONE PUMP SUCTION LINE (BY CONTRACTOR) FROM No. 2, 1500 GAL. UNDERGROUND TANK
- D 1" HYDROCYCLONE DISCHARGE LINE (BY CONTRACTOR) TO WASH BAY CATCH BASIN

C - 2" HYDROCYCLONE PUMP SUCTION LINE ("SPARE"/ BY CONTRACTOR) FROM No. 2, 1500 GAL. UNDERGROUND TANK

- E 1" DOMESTIC WATER LINE FROM CAR WASH FRESH WATER SUPPLY TO PRIME SYSTEM BYPASS NOT AVAILABLE (BY CONTRACTOR)
- F 1" SPARGER DISCHARGE LINE (BY CONTRACTOR) TO No. 1, 1500 GAL. UNDERGROUND TANK

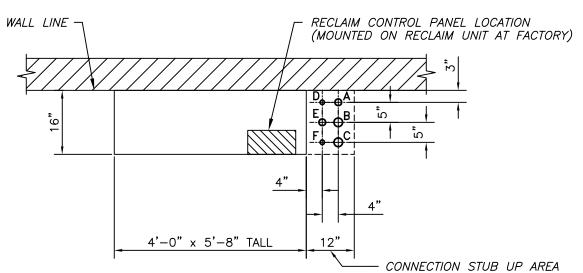

NOTES:

ROOM AND FRESH WATER SUPPLY LOCATIONS


- 1) CONTRACTOR TO STUB UP LINES *A; B; C; D; *E; & F 10" TO 12" (A.F.F.) ABOVE FINISHED FLOOR (*SEE NOTE 3)
- 2) ALL UNDERGROUND PIPING USED ON RECLAIM SYSTEM TO BE PVC, SCH. 80
 3) *DISCHARGE LINE "A" AND INPUT LINE "E" AT RECLAIM, CAN BE RUN ABOVE THE FLOOR SLAB DEPENDING ON EQUIPMENT

PLUMBING ROUGH IN PLAN VIEW

SCALE: 1/2" = 1'-0"

PW-200 RECLAIM SYSTEM


A PROPOSED PLAN OF: STAPLETON EASTRIDGE CAR WASH, LLC DENVER, COLORADO PRESENTED BY: Car Wash Systems - Copyright 2009 **PLUMBING** NO. DATE DESCRIPTION BY CHKD. REVISIONS DRAWN BY: ENGINEER: DRAWING NO. CMR 03-02-2009 EV1-0144 o SCALE: AS SHOWN CHECKED: SHEET 7 OF 12

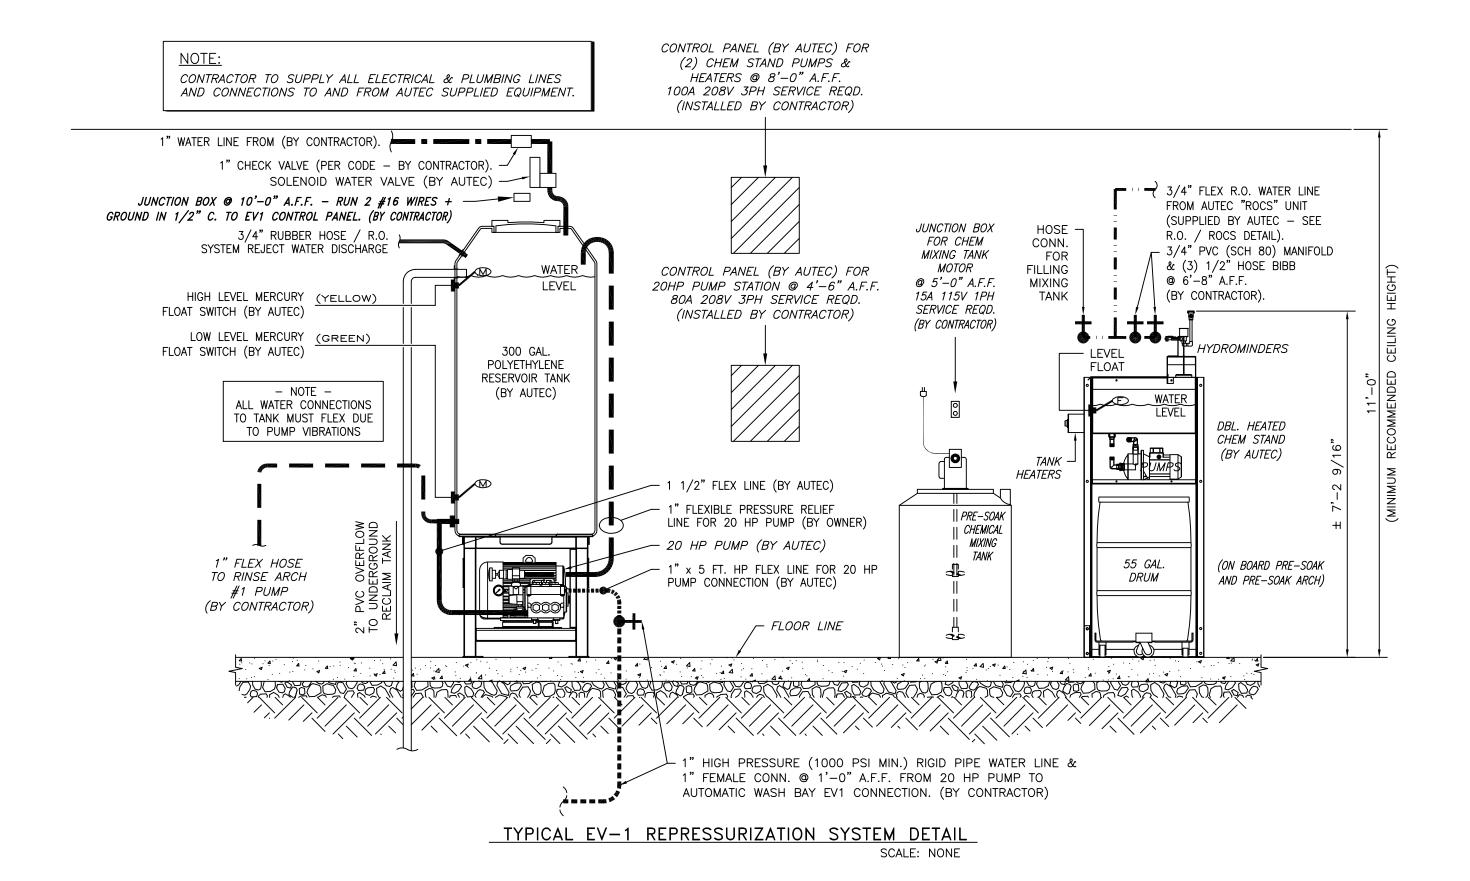

- 1. ALL ELECTRICAL, PLUMBING & COMPRESSED AIR LINES AND CONNECTIONS ARE THE <u>RESPONSIBILITY OF THE OWNER/GENERAL CONTRACTOR</u> AND ARE TO BE MADE BY QUALIFIED LICENSED PERSONNEL TO MEET STATE AND LOCAL CODES. NEITHER AUTEC OR THEIR REPRESENTATIVES SUPPLY OR INSTALL THESE ITEMS.
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PC-4500HV-HP SPOT FREE RINSE SYSTEM DETAIL


							STRID	OGE CAR WASH, I	LLC
						PRESENTED BY:		Copyright 2009	
			CRIPTION	BY	CHKD.	Р	LUM 3	BING B	
	WN BY: (CMR	ENGINEER:			DATE: 03-02-2009 SCALE: AS SHOWN)	DRAWING NO. EV1-0144 SHEET 8 OF 12	REV.

SCALE: NONE

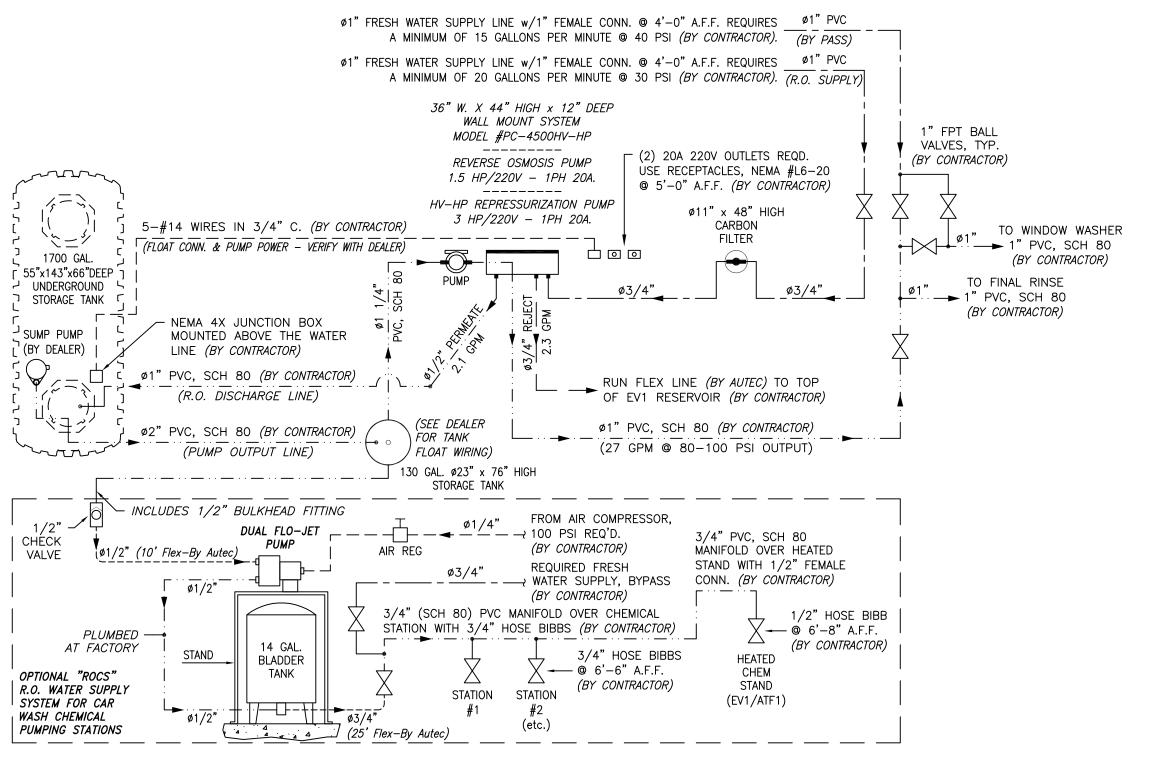	NATURAL GAS APPLIANCE SCHEDULE									
MARK	FIXTURE	MANUF.	GAS SUPPLY	VENT STACK SIZE						
G-1	BAY HEATER	RE-VERBER-RAY 100,000 BTUH INPUT	1/2"	4" ROUND						

MECHANICAL NOTES:

- GAS PIPING TO BE "BLACK" IRON. PROVIDE HANGERS FOR GAS PIPING @ 48"
 O.C. MAX.
- 2. PROVIDE CONDENSATE DROP @ LOW POINT IN GAS LINE.
- 3. COMBUSTION AIR FOR GAS APPLIANCE (BAY HEATER) TO BE PROVIDED WITH ONE Ø4" AIR INLET THROUGH ROOF, LOCATED ABOVE BURNER IN CARWASH BAY.
- 4. MINIMUM DISTANCE BETWEEN AIR INTAKE AND GAS VENTS IS 10'.
- 5. MINIMUM HEIGHT OF VENT CAP FOR GAS APPLIANCE TO BE 36" ABOVE ROOF.
- 6. VENT STACKS TO BE TYPE "B" METAL.

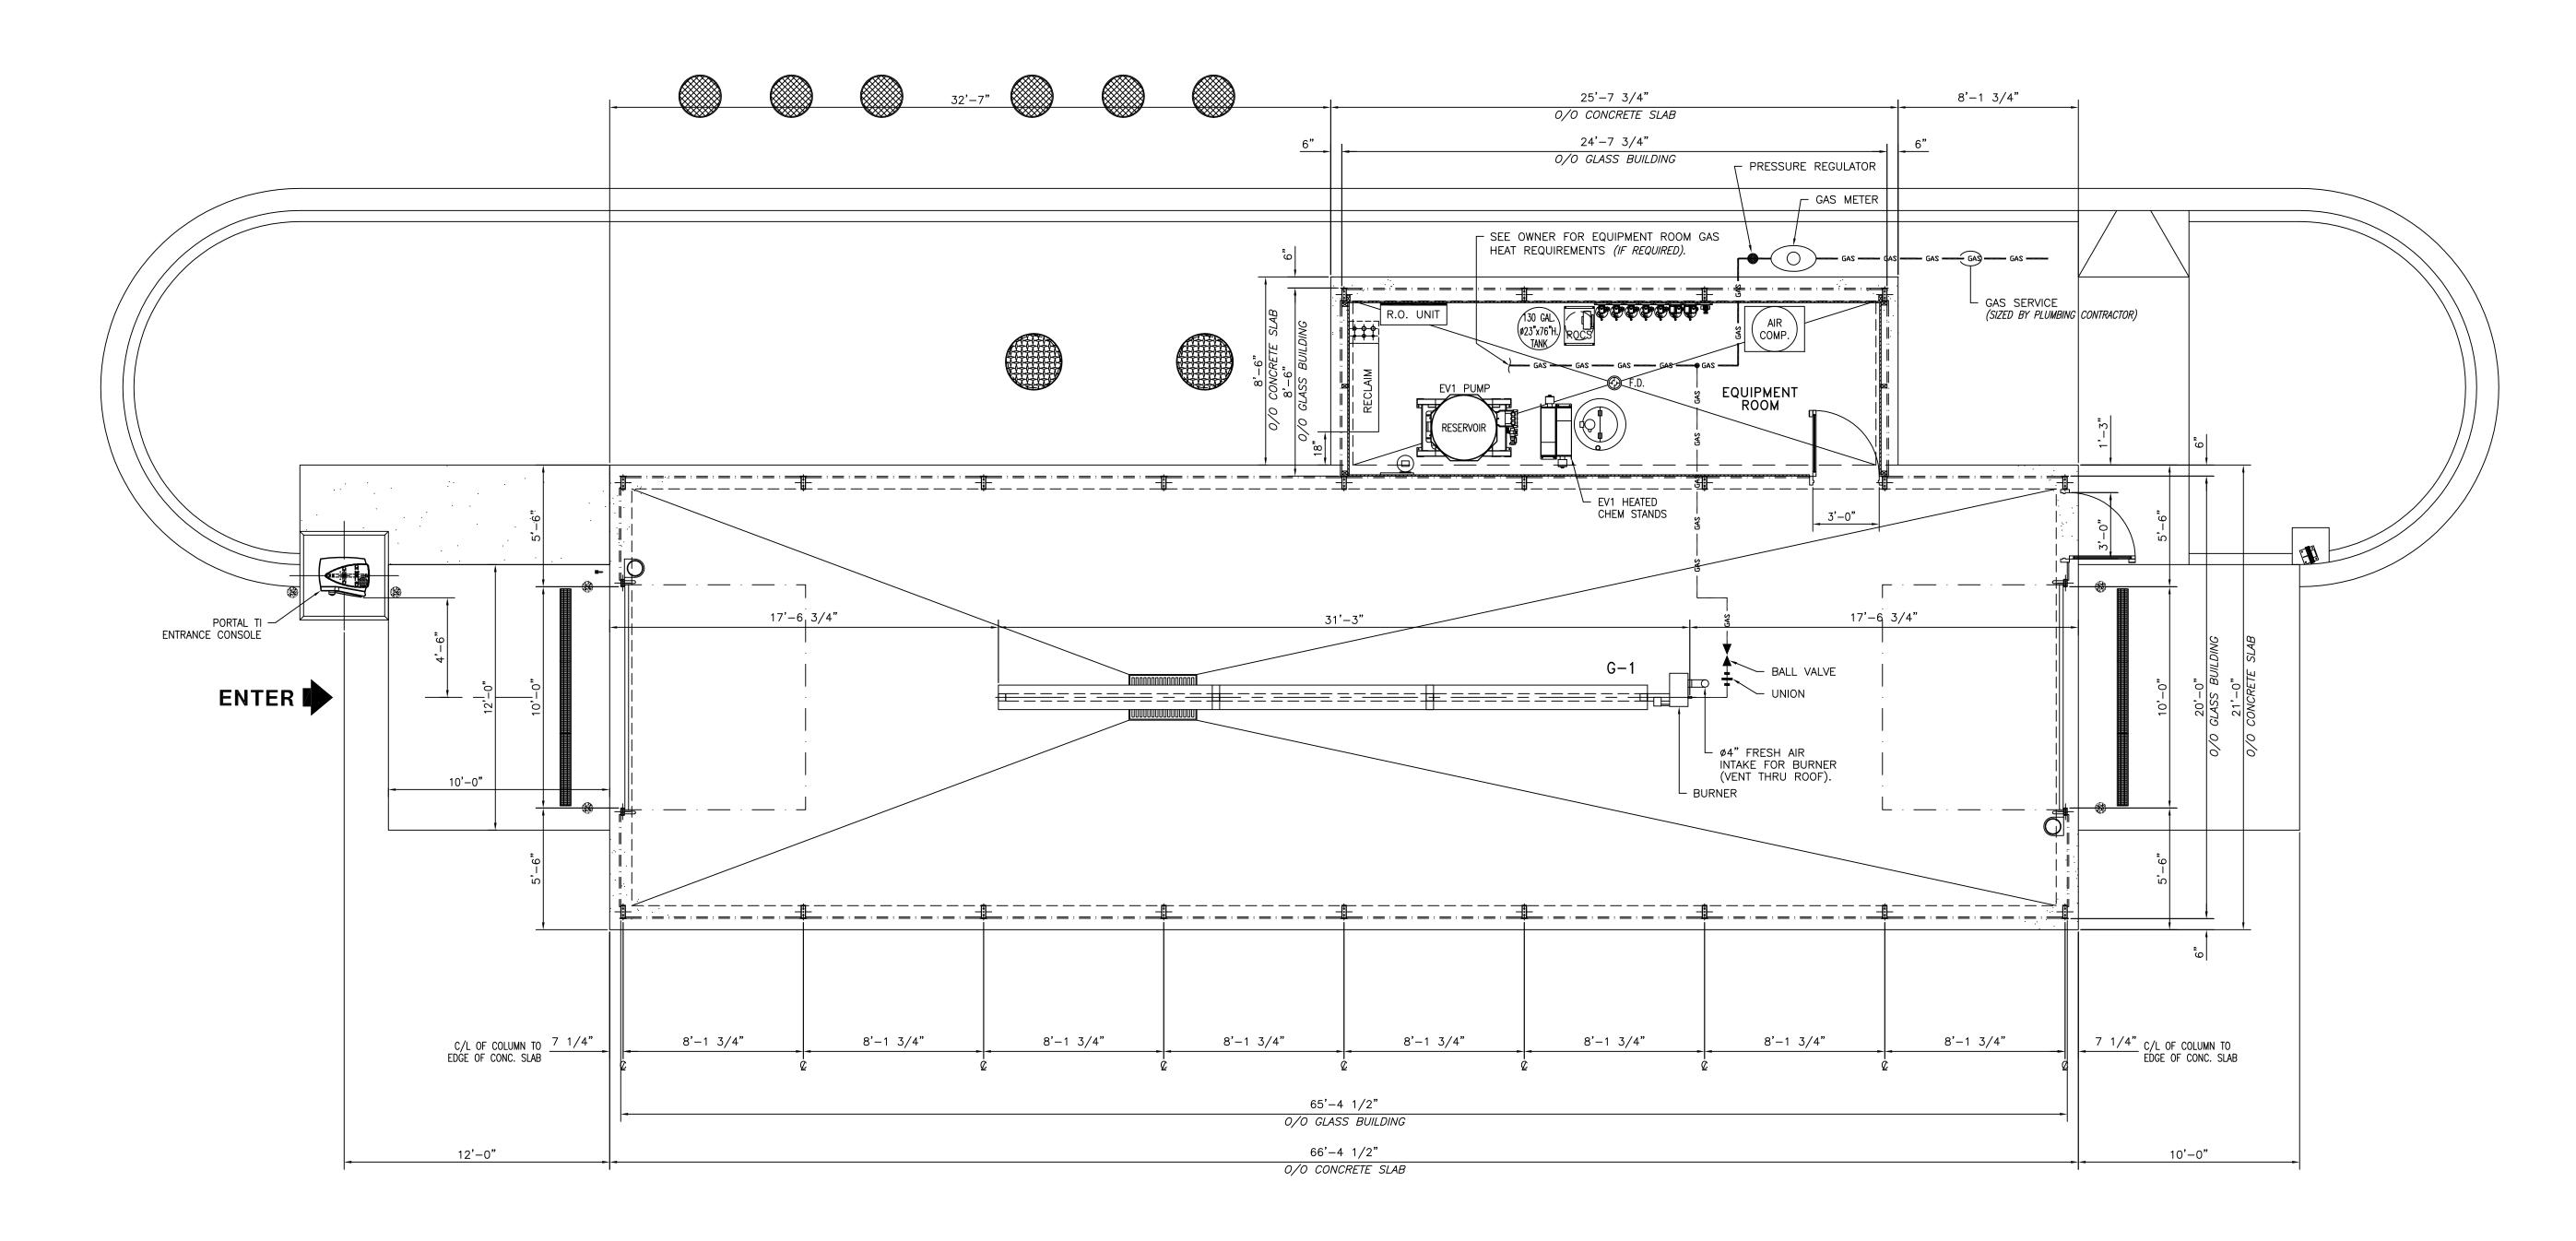

GENERAL NOTES:

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MECHANICAL PLAN SCALE: 1/4" = 1'-0"

				RIDGE CAR WASH, LLC COLORADO
			PRESENTED BY: Car Wash System	ms - Capyright 2009
- NOTE - THE INFORMATION ON THIS DRAWING IS	NO. DATE	DESCRIPTION BY REVISIONS	снкр. МЕСН	ANICAL
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	•		AS SHOWN	SHEET 9 OF 12